
GENERAL NOTES:

- 1. ALL FASTENERS SHALL BE IN ACCORDANCE WITH THESE DRAWINGS. SPECIFIED ANCHOR EMBED TO BASE MATERIAL SHALL BE BEYOND WALL FINISH OR STUCCO.
- 2. OPENINGS, BUCKING & BUCKING FASTENERS MUST BE PROPERLY DESIGNED & INSTALLED TO TRANSFER WIND LOADS TO THE STRUCTURE.
- 3. THESE NON-IMPACT RATED PRODUCT INSTALLATIONS ARE IN ACCORDANCE WITH AND MEET THE REQUIREMENTS OF THE 2018 INTERNATIONAL BUILDING CODE (IBC).
- 4. ALL ANCHORS SECURING PRODUCT FRAME TO PRESSURE TREATED BUCKS OR WOOD FRAMING SHALL BE CAPABLE OF RESISTING CORROSION CAUSED BY THE PRESSURE TREATING CHEMICALS IN THE WOOD.
- 5. TO THE BEST OF OUR KNOWLEDGE, THE PRODUCT SHOWN HEREIN IS CERTIFIED & QUALITY ASSURED BY A NATIONALLY ACCREDITED CERTIFICATION/QA ENTITY & SHALL BE LABELED IN ACCORDANCE WITH CERTIFICATION/QA ENTITIES SPECIFICATIONS. PRODUCT ASSEMBLY IS NOT PART OF THIS DRAWING AND SHALL BE IN ACCORDANCE WITH THE MANUFACTURER'S QUALITY ASSURANCE SPECIFICATIONS & TESTING REPORTS
- 6. CERTIFICATION OF THESE PRODUCT INSTALLATIONS SHALL BE CONSIDERED VOID IF ANY OF THE FOLLOWING APPLY: 1) THEY ARE INSTALLED WITHOUT A BUILDING PERMIT FROM THE APPLICABLE LOCAL BUILDING DEPARTMENT. 2) IF THEY ARE INSTALLED BY ANYONE OTHER THAN A LICENSED CONTRACTOR EXPERIENCED WITH WINDOW/DOOR INSTALLATIONS. 3) IF CHANGES HAVE OCCURRED TO THE PRODUCT'S CERTIFICATION ENTITY'S CERTIFICATE THAT CAUSE THESE INSTALLATIONS TO BE INCORRECT OR INCONSISTENT WITH WHAT HAS BEFN TESTED.
- 7. THE LEAST DESIGN PRESSURE SPECIFIED EITHER IN THIS DRAWING OR IN THE PRODUCTS CERTIFICATION SHALL CONTROL FOR THE INSTALLED PRODUCT.
- 8. THESE DRAWINGS CERTIFY THE PRODUCT INSTALLATION ONLY. WATER PROOFING OF THE INSTALLED PRODUCT IS NOT PART OF THIS INSTALLATION CERTIFICATION. THAT RESPONSIBILITY SHALL BE THAT OF THE MANUFACTURER &/OR INSTALLER.

INSTALLATION EVALUATION IS BASED ON APPLICABLE ANCHOR STANDARDS AND/OR INFORMATION & RESULTS FROM APPLICABLE TEST REPORTS. THE BUILDING CODE VERSION CONSIDERED WITH THE EVALUATION WAS THAT IN FORCE AT THE TIME OF THE EVALUATION. IN THE EVENT OF CODE VERSION CHANGES/UPDATES OR IN THE EVENT THAT NEW OR ADDITIONAL TESTING IS COMPLETED ON THE REFERENCED PRODUCT, PRIOR TO STATING CODE COMPLIANCE, THE MANUFACTURER SHALL CONFIRM WITH THE INSTALLATION EVALUATION ENGINEER OF RECORD THAT THE INSTALLATIONS SPECIFIED HERE—IN ARE CURRENT WITH THE THEN CURRENT TESTING, CODE AND APPLICABLE STANDARDS.

FRAME ANC	HOR REQUIREMENTS TABLE				
OPENING TYPE (SUBSTRATE)	FRAME/CLIP/NAIL FIN TO OPENING FASTENER TYPE	MINIMUM EMBED	MINIMUM EDGE DIST.		
(1) FRA	ME SCREWS				
MIN. 2X4 WOOD FRAME OR BUCK (MIN. GR. 3 & G=0.55)	NO. 10 SMS OR WOOD SCREW	1 1/4"	3/4"		
MIN. 18 GA. 33 KSI METAL STUD	NO. 10 GR. 5 SELF TAP/DRILL SCREW	FULL	1/2"		
MIN. 1/8" THK A36 STEEL	NO. 10 GR. 5 SELF TAP/DRILL SCREW	FULL	1/2"		
MIN. 1/8" THK 6063-T5 ALUM.	NO. 10 GR. 5 SELF TAP/DRILL SCREW	FULL	1/2"		
MIN. C-90 CMU OR 2500 PSI CONCRETE	(2) 1/4" CONCRETE SCREW	1 1/4"	2"		
(1) INSTAL	LATION CLIP SCREWS				
MIN. 2X4 WOOD FRAME OR BUCK (MIN. GR. 3 & G=0.55)	NO. 10 SMS SCREW	1 1/4"	1/2"		
MIN. 18 GA. 33 KSI METAL STUD	NO. 10 GR. 5 SELF TAP/DRILL SCREW	FULL	1/2"		
MIN. 1/8" THK A36 STEEL	NO. 10 GR. 5 SELF TAP/DRILL SCREW	FULL	1/2"		
MIN. 1/8" THK 6063-T5 ALUM.	NO. 10 GR. 5 SELF TAP/DRILL SCREW	FULL	1/2"		
2500 PSI CONCRETE	(2) 3/16" CONCRETE SCREW	1 1/4"	2"		
(3) NAIL	ING FIN FASTENERS				
MIN. 2X4 WOOD FRAME OR BUCK (MIN. GR. 3 & G=0.55)	NO. 10 SMS SCREW	1 3/8"	1/2"		
MIN. 2X4 WOOD FRAME OR BUCK (MIN. GR. 3 & G=0.55)	11 GA. ROOFING NAIL	1 3/8"	1/2"		
MIN. 1/8" THK A36 STEEL	NO. 8 GR. 5 SELF TAP/DRILL SCREW	FULL	1/2"		
MIN. 1/8" THK 6063-T5 ALUM.	NO. 8 GR. 5 SELF TAP/DRILL SCREW	FULL	1/2"		
(4) FRANCIAND INSTANTATION ONE CONTINUE CHAIL DE A DAN OR HEVILLAR COREW					

- (1) FRAME AND INSTALLATION CLIP SCREWS SHALL BE A PAN OR HEX HEAD SCREW.
- (2) CONCRETE SCREWS SHALL BE ELCO ULTRACONS (C.S.), ELCO CRETE-FLEX (S.S.), ITW RAMSET/RED HEAD TAPCONS (C.S. OR S.S.) OR HILTI KWIK-CON II (C.S OR S.S.).
- (3) WHEN SCREWS ARE USED WITH THE NAIL FIN, THEY MUST BE A PAN HEAD OR WAFFLE HEAD SCREW OR HAVE A FLAT WASHER AT THE SCREW HEAD.

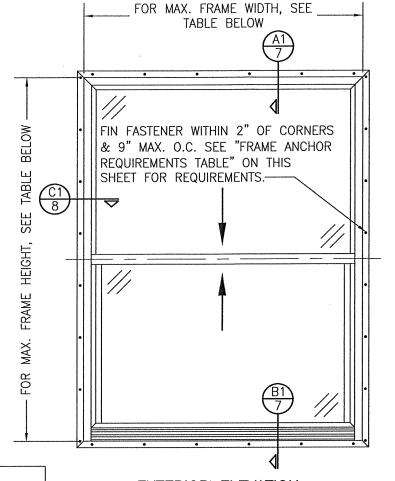

EXTERIOR ELEVATION: SINGLE WINDOW

SCALE: 3/4" = 1'-0"
(NAIL FIN MOUNT CONDITION)

FOR MAX. FRAME WIDTH, SEE TABLE BELOW 4" MAX. ပ Ö 8/0 TABLE SEE HEIGHT, FRAME \circ MAX. FRAME SCREWS WHERE SHOWN AT SIDES. SEE "FRAME ANCHOR REQUIREMENTS TABLE" ON THIS SHEET FOR REQUIREMENTS. 4" MAX. **EXTERIOR ELEVATION:**

XTERIOR ELEVATION SINGLE WINDOW

SCALE: 3/4" = 1'-0" (FRAME SCREW MOUNT CONDITION)

ALLOWABLE DESIGN PRESSURE (SINGLE WINDOWS)

(SINGLE WINDOWS)							
	MAX. FRAME WIDTH (IN.)	MAX. FRAME HEIGHT (IN.)	ALLOWABLE PRESSURE (+/- PSF)				
	48	63	30				
	36	72	30				
	36	63	35				

INSTALLATION NOTE:
WHEN NECESSARY, INSTALLATION METHODS
MAY BE MIXED WITH ANY ONE WINDOW SUCH
THAT INDIVIDUAL SIDES OF THE WINDOW MAY
USE ONE OR THE OTHER ANCHOR METHOD
(EXAMPLE: SILL MAY USE FRAME SCREWS
METHOD WHILE OTHER SIDES USE FIN)

ANCHOR/SUBSTRATE EVALUATION NOTE:
ALL ANCHORS IN THEIR SPECIFIED SUBSTRATES
HAVE BEEN ANALYZED IN ACCORDANCE WITH
THEIR APPLICABLE STANDARD(S) AND ARE FOUND
TO BE CAPABLE OF SUPPORTING ALL LOADS
IMPOSED ON THEM UNDER THE GUIDELINES OF
THIS DOCUMENT. ANY SUBSTRATES OR
CONDITIONS OUTSIDE OF WHAT IS SHOWN
HERE-IN SHALL BE SUBJECT TO JOB SPECIFIC
ENGINEER'S REVIEW & CERTIFICATION.

CONDITIONS SHOWN IN THESE DRAWINGS ARE GOVERNED BY INSTALLATION REQUIREMENTS ONLY. THE GOVERNING CONDITIONS ON ANY SPECIFIC PRODUCT SHALL BE THE LESSER OF THOSE SPECIFIED IN THE PRODUCTS TDI APPROVAL OR THAT SHOWN IN THESE DRAWINGS.

THESE DRAWINGS ARE APPLICABLE ONLY TO THE PRODUCT SPECIFIED. THEY MAY NOT BE USED FOR THE ASSEMBLY AND/OR INSTALLATION OF ANY OTHER PRODUCT NOR MAY THEY BE USED FOR RATIONAL AND/OR LOCAL APPROVAL OF ANY PRODUCT NOT PRODUCED BY THE MANUFACTURER STATED ON THESE DRAWINGS.


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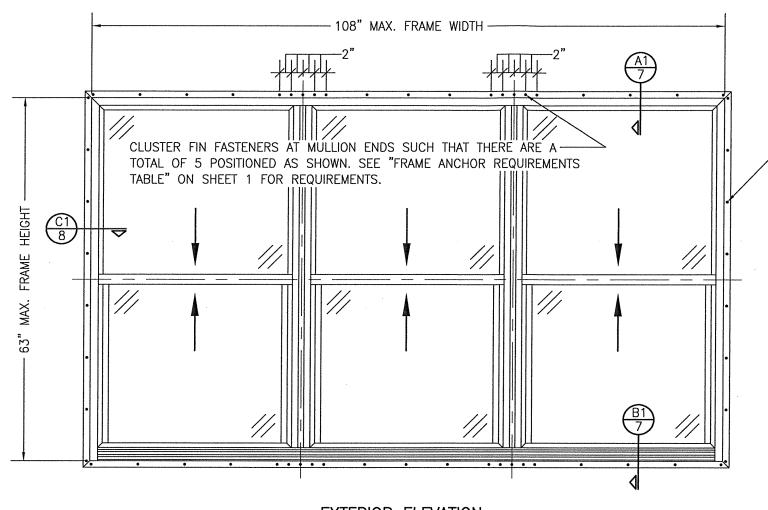
SHEET NO.

of 8

W.W.S.

DATE: 04/20/20



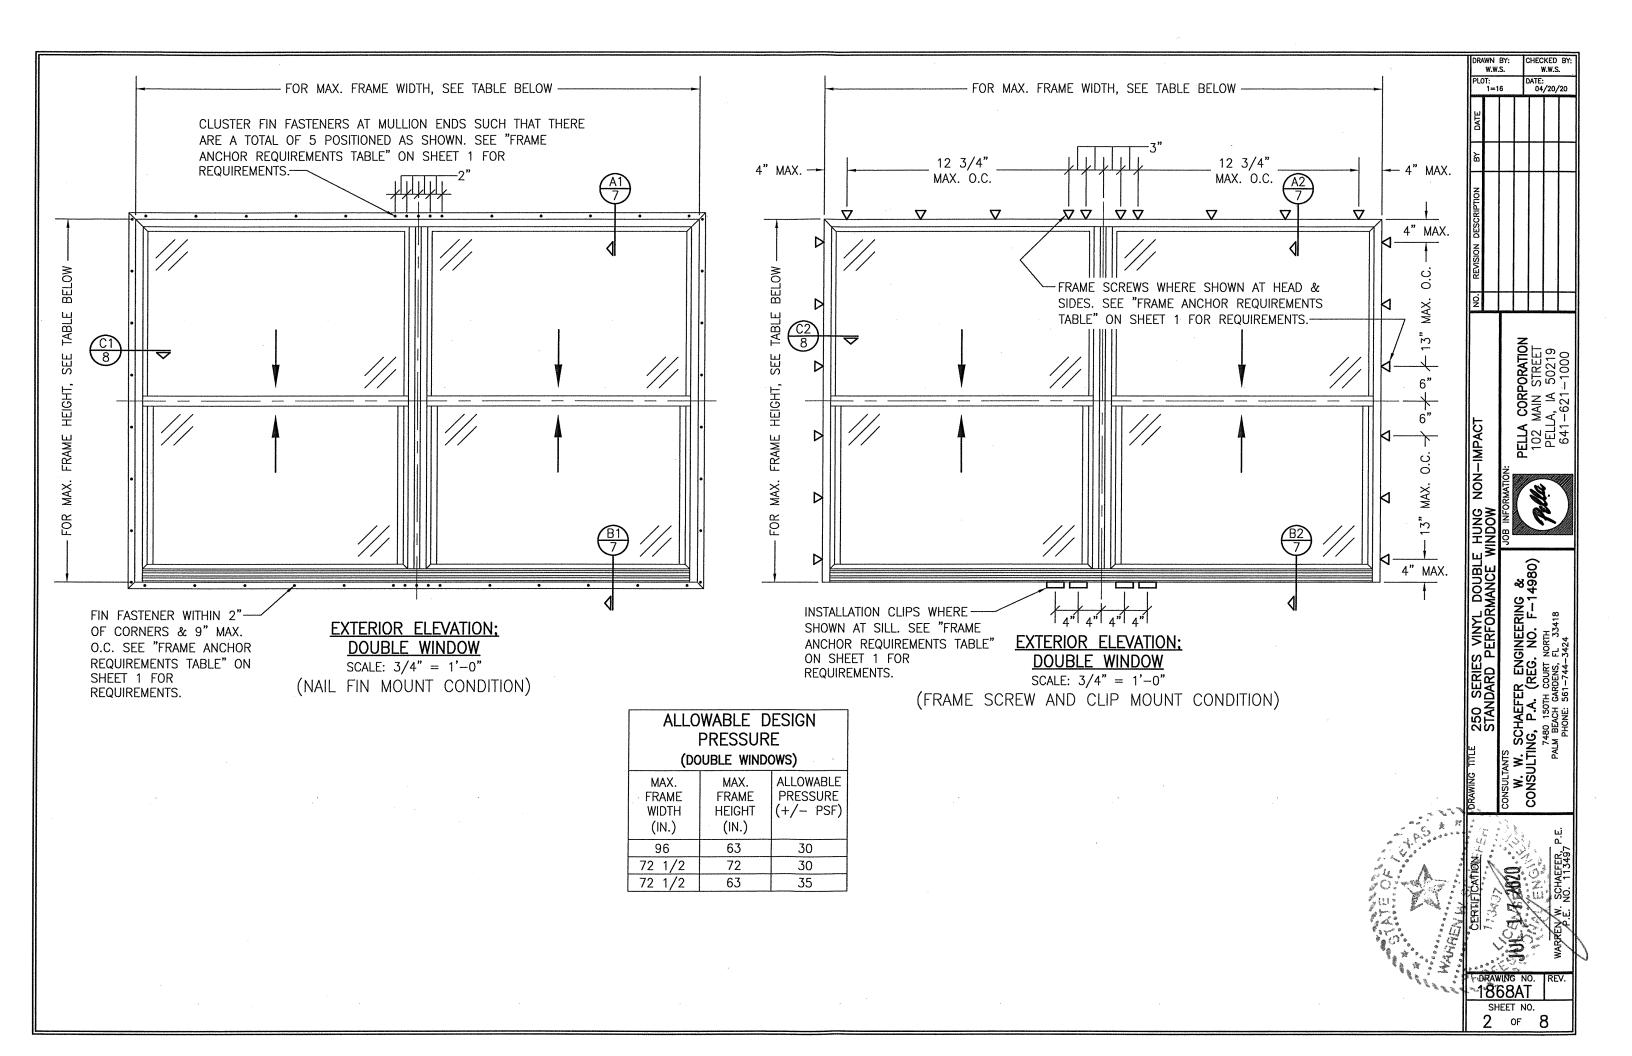

-FIN FASTENER WITHIN 2" OF CORNERS & 9" MAX. O.C. SEE "FRAME ANCHOR REQUIREMENTS TABLE" ON SHEET 1 FOR REQUIREMENTS.

EXTERIOR ELEVATION; TRIPLE WINDOW

SCALE: 3/4" = 1'-0"(NAIL FIN MOUNT CONDITION)


ALLOWABLE DESIGN PRESSURE (108" X 63" TRIPLE WINDOW UNITS)

+/-35 PSF

DATE: 04/20/20

DRAWING NO. 1868AT

SHEET NO. 3 OF 8

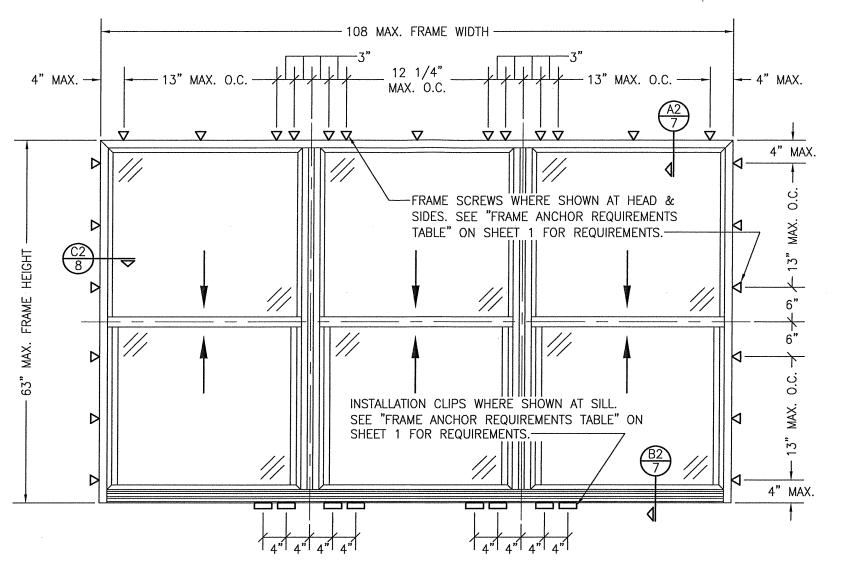

EXTERIOR ELEVATION: TRIPLE WINDOW

SCALE: 3/4" = 1'-0"


(FRAME SCREW AND CLIP MOUNT CONDITION)


ALLOWABLE DESIGN PRESSURE (108" X 63" TRIPLE WINDOW UNITS)

+/-35 PSF

W.W.S. PLOT: 1=16			+	W.W.S. DATE: 04/20/20		
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DATE						
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NO. REVISION DESCRIPTION					•	
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HUNG NON-IMPACT	MOONIA	JOB INFORMATION:	PELLA CORPORATION	102 MAIN STREET	PELLA, IA 50219	641-621-1000
WING TITLE 250 SERIES VINYL DOUBLE HUNG NON-IMPACT STANDARD BEBEODMANCE WINDOW	TONIVINIO INTL. ANDONOIS		W. SCHAE	CONSULTING, P.A. (REG. NO. F-14980)	7480 150TH COURT NORTH PALM BEACH GARDENS, FL 33418	PHONE: 561-744-3424
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4 of 8



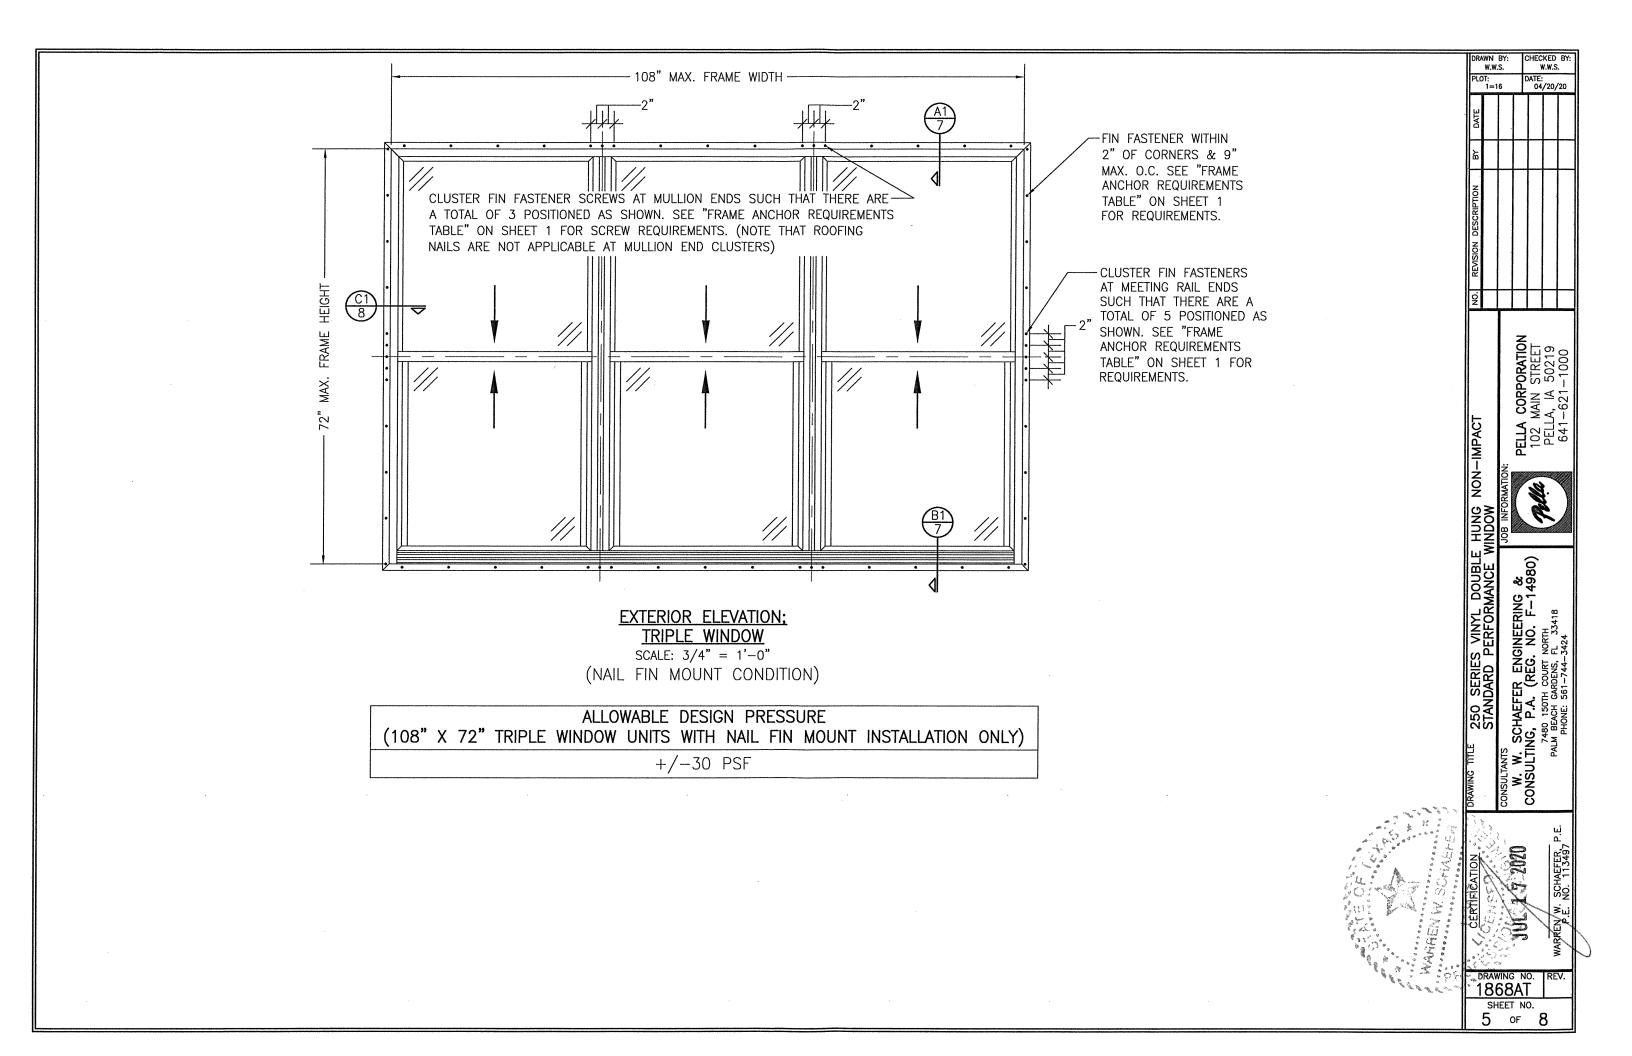

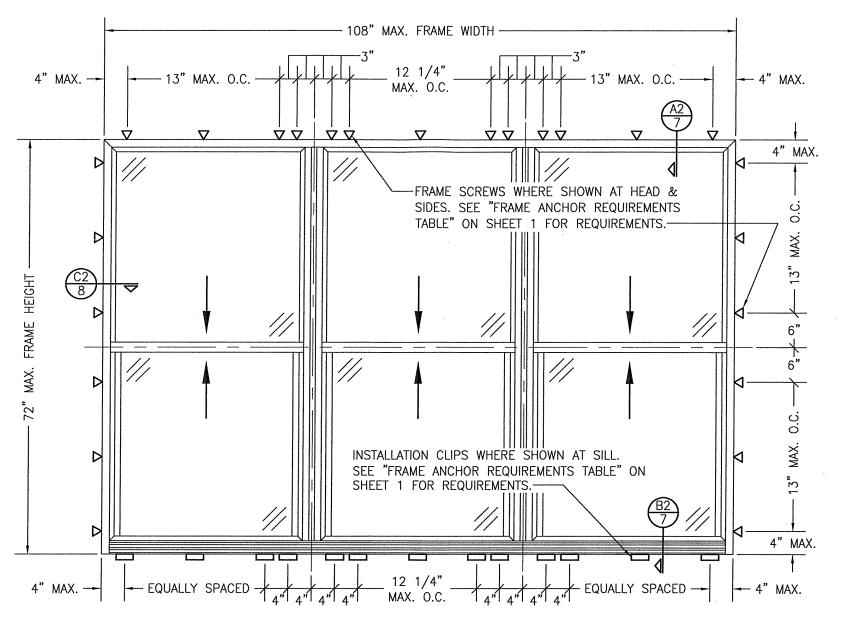EXTERIOR ELEVATION; TRIPLE WINDOW SCALE: 3/4" = 1'-0"

(FRAME SCREW AND CLIP MOUNT CONDITION)

ALLOWABLE DESIGN PRESSURE

(108" X 72" TRIPLE WINDOW UNITS WITH FRAME SCREW & CLIP MOUNT INSTALLATION ONLY)

+/-30 PSF

W. W. SCH. SCHAEFER, P.E. PHOI 113497 P.E. PHOI

