#### **GENERAL NOTES:**

- I. THIS PRODUCT HAS BEEN TESTED, ANALYZED & APPROVED FOR DESIGN PRESSURES NOT TO EXCEED THOSE SHOWN IN THE "ALLOWABLE DESIGN PRESSURE TABLE(S).
- 2. OPENINGS, BUCKING & BUCKING FASTENERS MUST BE PROPERLY DESIGNED & INSTALLED TO TRANSFER WIND LOADS TO THE STRUCTURE.
- 3. ALL HARDWARE & FASTENERS SHALL BE IN ACCORDANCE WITH THESE DRAWINGS & SHALL NOT VARY UNLESS SPECIFICALLY MENTIONED ON THE DRAWINGS. SPECIFIED ANCHOR EMBED TO BASE MATERIAL SHALL BE BEYOND WALL FINISH OR STUCCO.
- 4. THE DETAILS & SPECIFICATIONS SHOWN HEREIN REPRESENT THE PRODUCTS TESTED & PROPOSED CONSTRUCTION' FOR WATER, AIR, IMPACT, CYCLIC & UNIFORM STATIC AIR PRESSURE TESTING IN CONFORMANCE WITH 2018 IBC REFERENCED STANDARDS ASTM E330, E283, E331, E1886 & E1996 & AAMA 1304 FOR LARGE & SMALL MISSILE IMPACT PRODUCTS. ALL TESTING OF THIS PRODUCT TO STANDARDS LESS CURRENT THAN THOSE SPECIFIED IN THE 2018 IBC HAS BEEN DETERMINED EQUIVALENT TO THE MORE CURRENT VERSIONS OF THOSE STANDARDS REFERENCED IN THE 2018 IBC.
- 5. THIS PRODUCT HAS BEEN DESIGNED IN ACCORDANCE WITH AND MEETS THE REQUIREMENTS OF THE 2018 INTERNATIONAL BUILDING CODE (IBC) & IS BOTH LARGE & SMALL MISSILE IMPACT RATED.

  6. WHEN GLAZED FOR SMALL MISSILE IMPACT, THIS PRODUCT MAY NOT BE INSTALLED AT
- ELEVATIONS BELOW 30 FT. ABOVE GRADE OR AT ANY CODE DESIGNATED LARGE MISSILE IMPACT LOCATION WITHOUT AN APPROVED SHUTTER.
- 7. WHEN LARGE MISSILE IMPACT GLAZED, IMPACT SHUTTERS ARE NOT REQUIRED WITH THIS PRODUCT
- 8. ALL ANCHORS SECURING PRODUCT FRAMES TO PRESSURE TREATED BUCKS OR WOOD FRAMING SHALL BE CAPABLE OF RESISTING CORROSION CAUSED BY THE PRESSURE TREATING CHEMICALS IN
- 9. DETERMINE THE POSITIVE & NEGATIVE DESIGN LOADS TO USE WHEN REFERENCING THESE DOCUMENTS IN ACCORDANCE WITH THE GOVERNING CODE AND GOVERNING WIND VELOCITY. FOR WIND LOAD CALCULATIONS IN ACCORDANCE WITH THE INTERNATIONAL BUILDING CODE, A DIRECTIONALITY FACTOR OF KD = 0.85 MAY BE APPLIED PER THE ASCE-7 STANDARD 10. MATERIALS, INCLUDING BUT NOT LIMITED TO STEEL SCREWS, THAT COME INTO CONTACT WITH OTHER DISSIMILAR MATERIALS SHALL BE SEPARATED OR COATED AS REQUIRED TO AVOID CORROSION OF EITHER MATERIAL.
- 11. TO THE BEST OF OUR KNOWLEDGE, THE PRODUCT SHOWN HEREIN ARE QUALITY ASSURED BY AN APPROVED CERTIFICATION/QA ENTITY & SHALL BE LABELED IN ACCORDANCE WITH APPLICABLE STANDARDS. THESE DRAWINGS SHOW ALL APPLICABLE ELEVATION, COMBINATION, INSTALLATION & COMPARATIVE ANALYSIS CONDITIONS AS DETERMINED THROUGH TESTING & ENGINEERING RATIONAL ANALYSIS. PRODUCT ASSEMBLY SHALL BE IN ACCORDANCE WITH THESE DRAWINGS, THE MANUFACTURER'S QUALITY ASSURANCE SPECIFICATIONS & TESTING REPORTS.

  12. CERTIFICATION OF THIS PRODUCT SHALL BE CONSIDERED VOID IF THEY ARE INSTALLED WITHOUT
- A BUILDING PERMIT FROM THE APPLICABLE LOCAL BUILDING DEPARTMENT OR IF THEY ARE INSTALLED BY ANYONE OTHER THAN A LICENSED CONTRACTOR EXPERIENCED WITH INSTALLATIONS OF THIS TYPE OF PRODUCT


EVALUATION OF THIS PRODUCT IS BASED ON APPLICABLE STANDARDS AND/OR INFORMATION & RESULTS FROM APPLICABLE TEST REPORTS. THE BUILDING CODE VERSION CONSIDERED WITH THIS EVALUATION WAS THAT IN FORCE AT THE TIME OF THE EVALUATION. IN THE EVENT OF CODE VERSION CHANGES/UPDATES OR IN THE EVENT THAT NEW OR ADDITIONAL TESTING IS COMPLETED ON THIS PRODUCT, PRIOR TO STATING CODE COMPLIANCE, THE MANUFACTURER SHALL CONFIRM WITH THE EVALUATION ENGINEER OF RECORD THAT EVERYTHING SPECIFIED HERE-IN IS CURRENT WITH ALL CURRENT TESTING, CODES AND APPLICABLE STANDARDS.

#### CORNER CONSTRUCTION:

FRAME ASSEMBLY: HORIZONTAL MEMBERS RUN THROUGH WITH VERTICAL MEMBERS RUNNING BETWEEN THE HORIZONTALS. BEFORE ASSEMBLY, SEALANT IS APPLIED TO THE VERTICAL MEMBER ENDS, . THE VERTICAL MEMBER ENDS ARE THEN BUTTED TO THE HORIZONTAL MEMBERS, SCREW HOLES ARE FILLED WITH SEALANT AND THE MEMBERS ARE JOINED WITH #12X2" HWH THREAD FORMING SCREWS (QUANTITIES VARY WITH LOCATION & MATCH THE QUANTITY OF AVAILABLE SCREW SPLINES). ONCE ASSEMBLED, SEALANT IS TOOLED AND ALL VOIDS FILLED. END DAMS ARE THEN PLACED TO CLOSE OFF THE HORIZONTAL MEMBER ENDS.

SUB-SASH & SLIDING PANEL ASSEMBLY: VERTICAL MEMBERS RUN THROUGH WITH HORIZONTAL MEMBERS RUNNING BETWEEN THE VERTICALS. SEALANT IS APPLIED TO THE HORIZONTAL ENDS AND GASKET RACEWAYS AND THE MEMBERS ARE JOINED WITH NO. 12 X 2" HWH THREAD FORMING SCREWS (QUANTITIES VARY WITH LOCATION & MATCH THE QUANTITY OF AVAILABLE SCREW SPLINES)

#### FRAME ANCHOR REQUIREMENTS TABLE FRAME & RECEPTOR SCREWS OPENING TYPE MINIMUM MINIMUM FRAME TO OPENING FASTENER TYPE (SUBSTRATE) EMBED EDGE DIST MIN. 2X4 WOOD FRAME OR BUCK NO. 14 SMS OR WOOD SCREW 1 1/4" (MIN. GR. 3 & G=0.55) 1/2" MIN. 16 GA. 50 KSI METAL STUD 1/4" GR. 5 SELF TAP/DRILL SCREW FULL MIN. 1/8" THK A36 STEEL 1/4" GR. 5 SELF TAP/DRILL SCREW 1/2' FULL 1/2" MIN. 0.100" THK 6063-T5 ALUM. 1/4" GR. 5 SELF TAP/DRILL SCREW FULL (1) (2) 1/4" CONCRETE SCREW 1 3/4" 2 1/2" MIN. C-90 CONCR. FILLED CMU (1) 1/4" CONCRETE SCREW 1 3/4" 2" MIN. 3000 PSI CONCRETE (1) CONCRETE SCREWS SHALL BE ELCO ULTRACONS (C.S.), ELCO CRETE-FLEX (S.S.), RAMSET/RED HEAD TAPCONS (C.S. OR S.S.) OR HILTI KWIK-CON II (C.S OR S.S.)

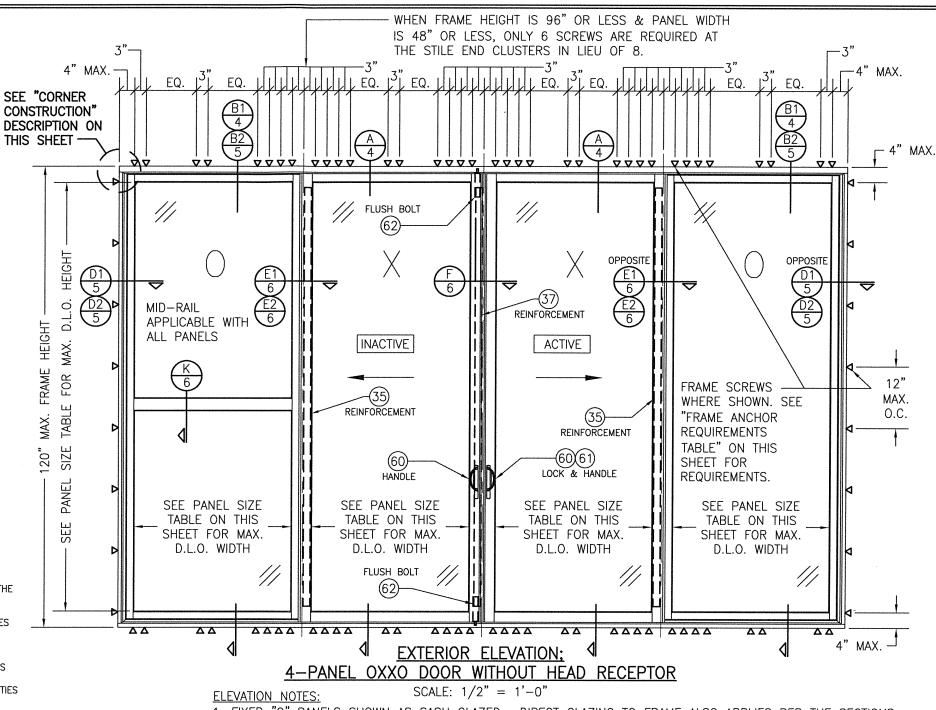

- 1. FIXED "O" PANELS SHOWN AS SASH GLAZED. DIRECT GLAZING TO FRAME ALSO APPLIES PER THE SECTIONS.
- 2. FOR HEAD RECEPTOR APPLICATION, SEE ELEVATION ON SHEET 3.
- 3. FOR APPLICABLE PANEL CONDITIONS AND "O"/"X" COMBINATIONS, SEE NOTATION ON SHEET 2.

ALLOWABLE PANEL SIZE TABLE (SASH GLAZED PANELS)		ALLOWABLE PANEL SIZE TABLE (DIRECT GLAZED PANELS)			
MAXIMUM D.L.O. WIDTH (IN.)	MAXIMUM D.L.O. HEIGHT (IN.)	MAXIMUM D.L.O. WIDTH (IN.)	MAXIMUM D.L.O. HEIGHT (IN.)		
53 15/16	87 1/2	57 15/16	91 1/2		
51	88 1/2	54	98 1/8		
48	94 1/16	51	103 15/16		
45	100 5/16	48	110 7/16		
42	107 1/2	44 1/2	115 1/2		
40 1/2	111 1/2				

THESE DRAWINGS ARE APPLICABLE ONLY TO TH PRODUCT SPECIFIED. THEY MAY NOT BE USED FOR THE ASSEMBLY AND/OR INSTALLATION OF ANY OTHER PRODUCT NOR MAY THEY BE USED FOR RATIONAL AND/OR LOCAL APPROVAL OF ANY PRODUCT NOT RODUCED BY THE MANUFACTURER STATED ON

1705T

2021

 On

CHECKED BY

W.W.S.

02/08/21

SMI)

શ્ર

 $\overline{\mathbb{R}}$ 

DOORS

GLASS

SLIDING

**PRESSURE** 

HGH

3200-IR

COMPANY, INC.
THRIDGE COURT
SS, GA 30092
-449-5555

KAWNEER 555 GUTH NORCROS

W. W. SCHAEFER ENGINEERING & W. W. SCHAEFER ENGINEERING & CONSULTING, P.A. (REG. NO. F-14980)

7480 150TH COURT NORTH
PALM BEACH GARDENS, FL. 33418

SHEET NO


OF


(2) CMU OPENINGS MUST HAVE REINFORCED CONCRETE FILLED CELLS AT THE SIDES.


ALLOWABLE DESIGN PRESSURE

(ALL UNITS)

+/-135 PSF

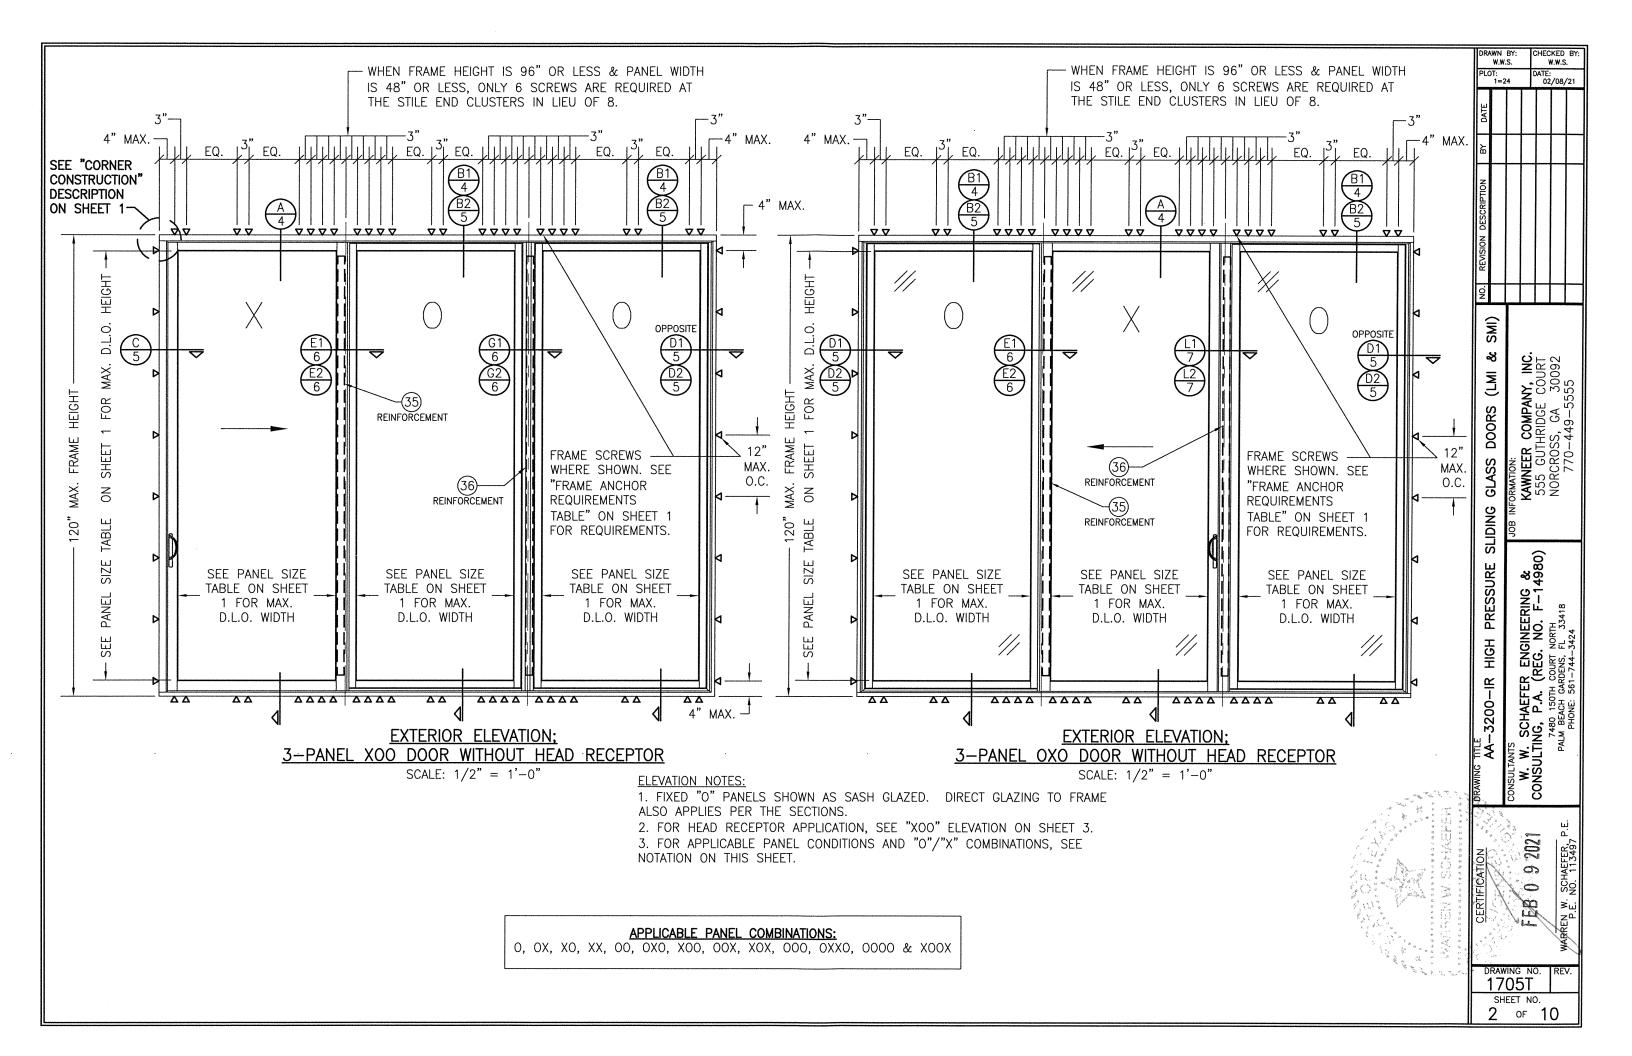


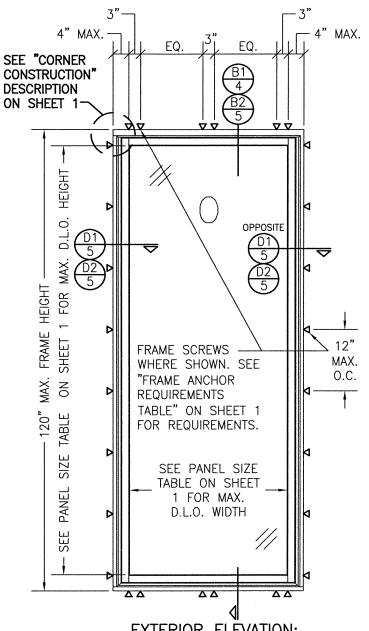

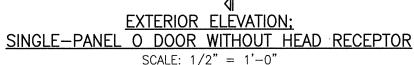

### **ELEVATION NOTES:**

- 1. FIXED "O" PANELS SHOWN AS SASH GLAZED. DIRECT GLAZING TO FRAME ALSO APPLIES PER THE SECTIONS.
- 2. FOR HEAD RECEPTOR APPLICATION, SEE "XOO" ELEVATION ON THIS SHEET.
- 3. FOR APPLICABLE PANEL CONDITIONS AND "O"/"X" COMBINATIONS, SEE NOTATION ON SHEET 2.

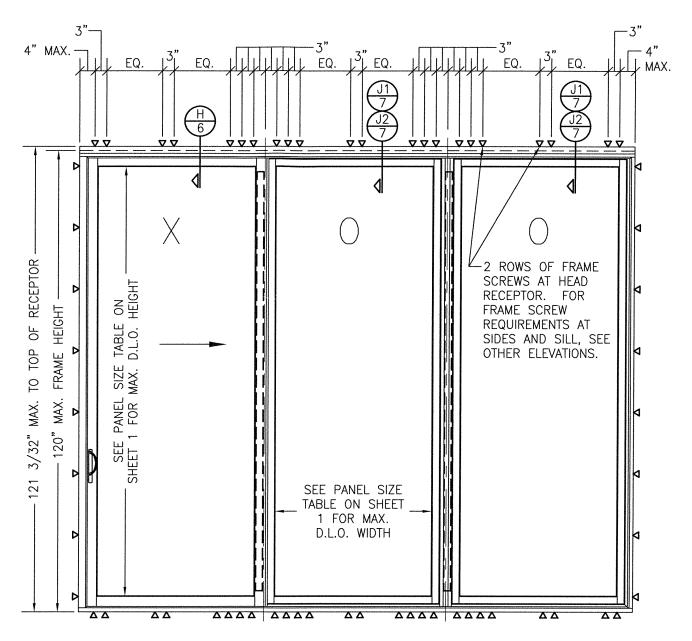

### EXTERIOR ELEVATION: 3-PANEL XOO DOOR WITH HEAD RECEPTOR


**ELEVATION NOTES:** 


SCALE: 1/2" = 1'-0"


- 1. FIXED "O" PANELS SHOWN AS SASH GLAZED. DIRECT GLAZING TO FRAME ALSO APPLIES PER THE SECTIONS.
- 2. THIS ELEVATION IS SHOWN ONLY FOR THE PURPOSE OF DETAILING THE HEAD RECEPTOR & ITS INSTALLATION. FOR ALL OTHER DETAIL, SEE OTHER ELEVATIONS.
- 3. HEAD RECEPTOR IS APPLICABLE FOR USE WITH ALL DOOR CONFIGURATIONS.
  4. FOR APPLICABLE PANEL CONDITIONS AND "O"/"X" COMBINATIONS, SEE NOTATION ON SHEET 2.


	W.V	PLOT:			DATE: 02/08/21			
		24 	02	/08/	/21			
	DATE							
	λá							
	REVISION DESCRIPTION							
	Ŏ.	Ш						
	TITLE AA-3200-IR HIGH PRESSURE SLIDING GLASS DOORS (LMI & SMI)	JOB INFORMATION: KAWNFER COMPANY INC		NORCROSS, GA 30092	//0-449-5555			
	RAWING TITLE AA-3200-IR HIGH PRESSURE SI	ONSULTANTS W. W. SCHAEFER ENGINEERING &	CONSULTING, P.A. (REG. NO. F-14980)	7480 150TH COURT NORTH PALM BEACH GARDENS, FL 33418	PHONE: 561–744–3424			
	CERTIFICATION	PR 00000		WARREN W SCHAFFER P F	P.E. NO. 113497			
	DRAI 17 SH 3	<u> 7057</u>	10. 10.	RE	V.			
1								


DRAWN BY: CHECKED BY:

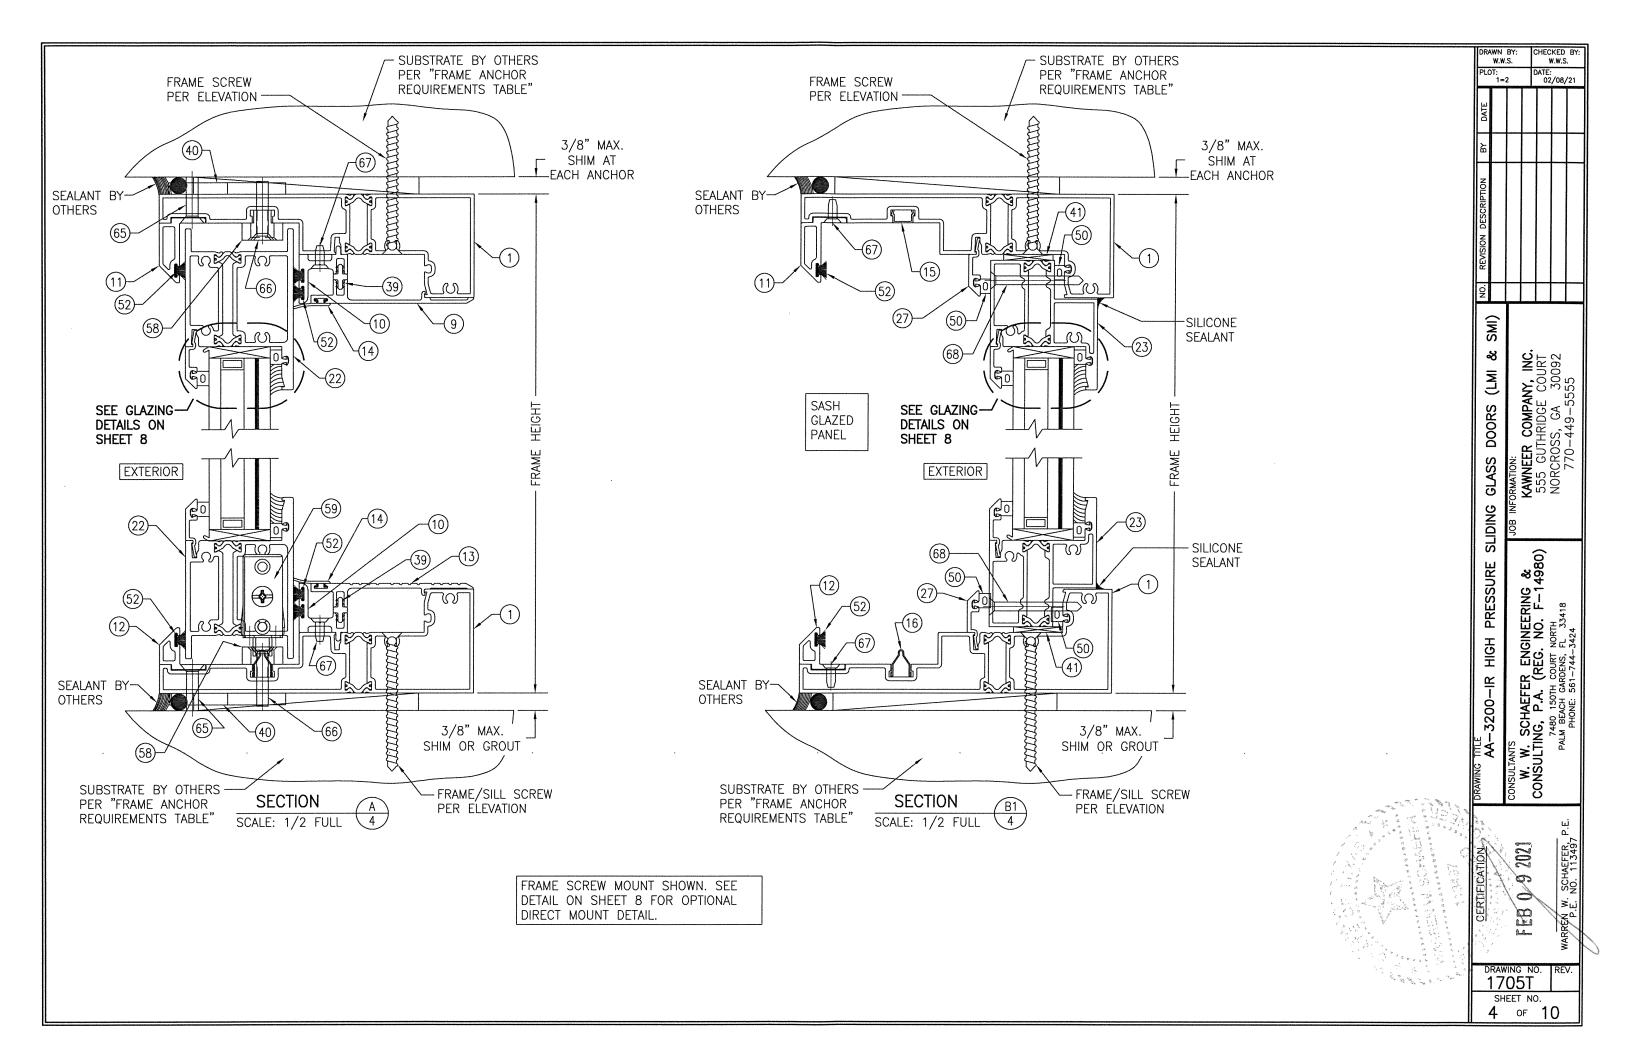

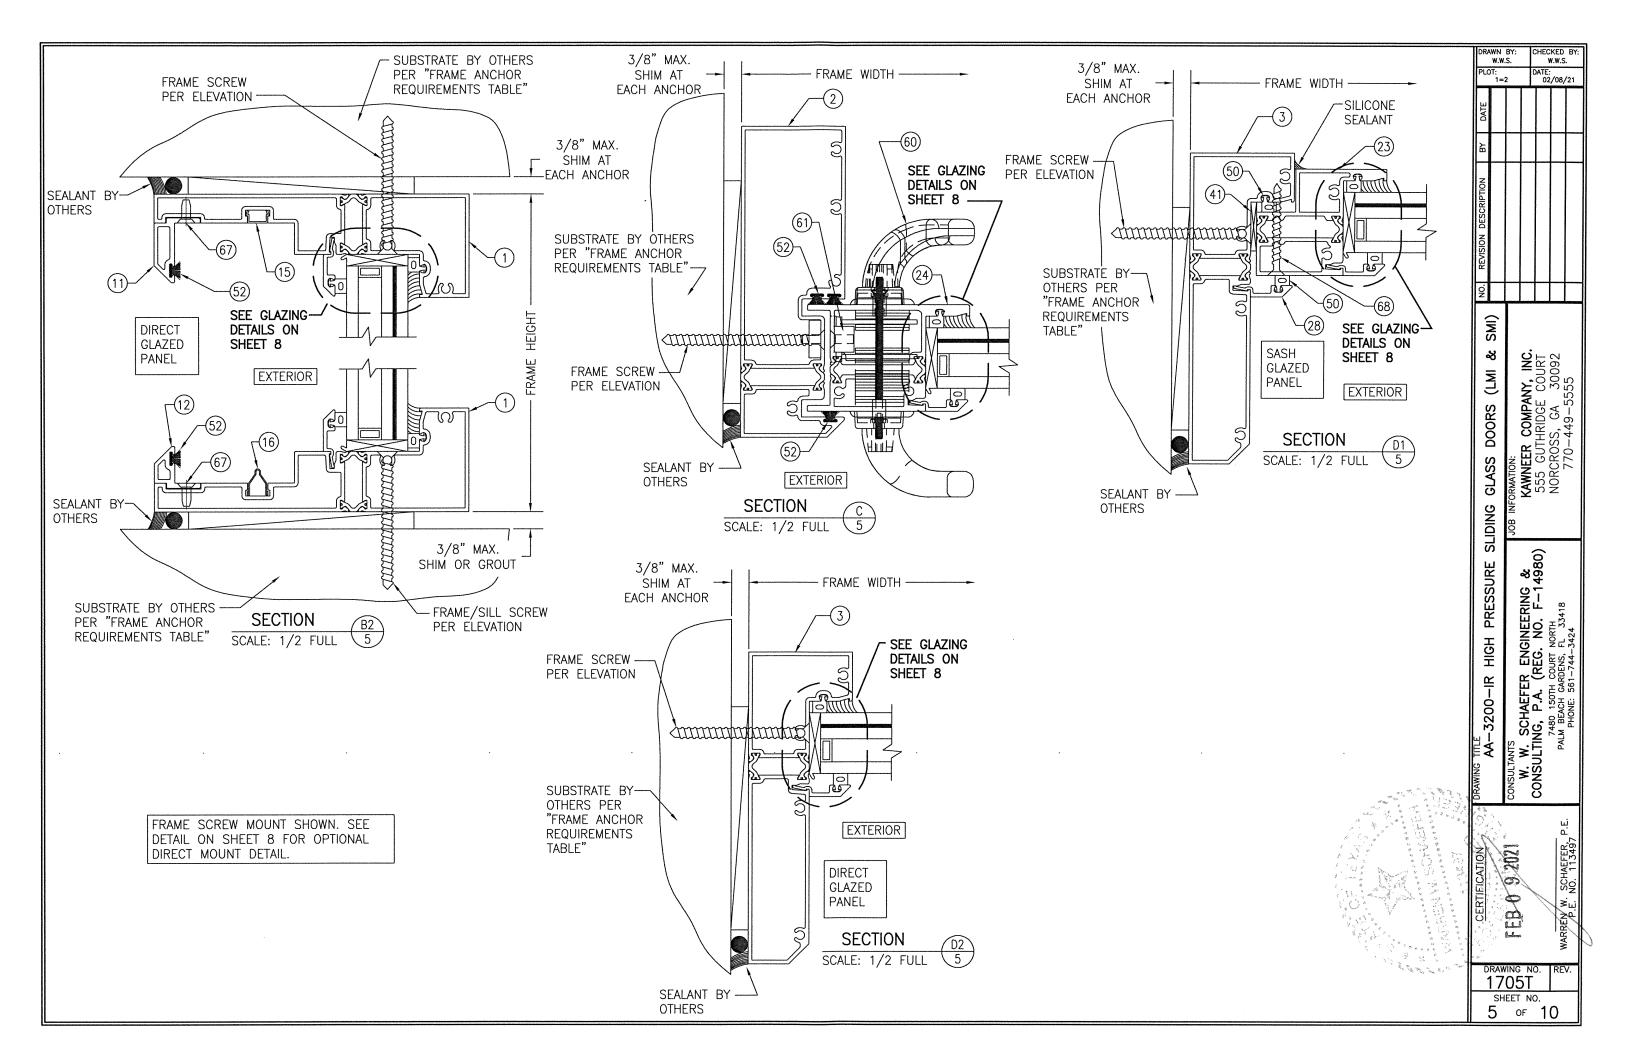

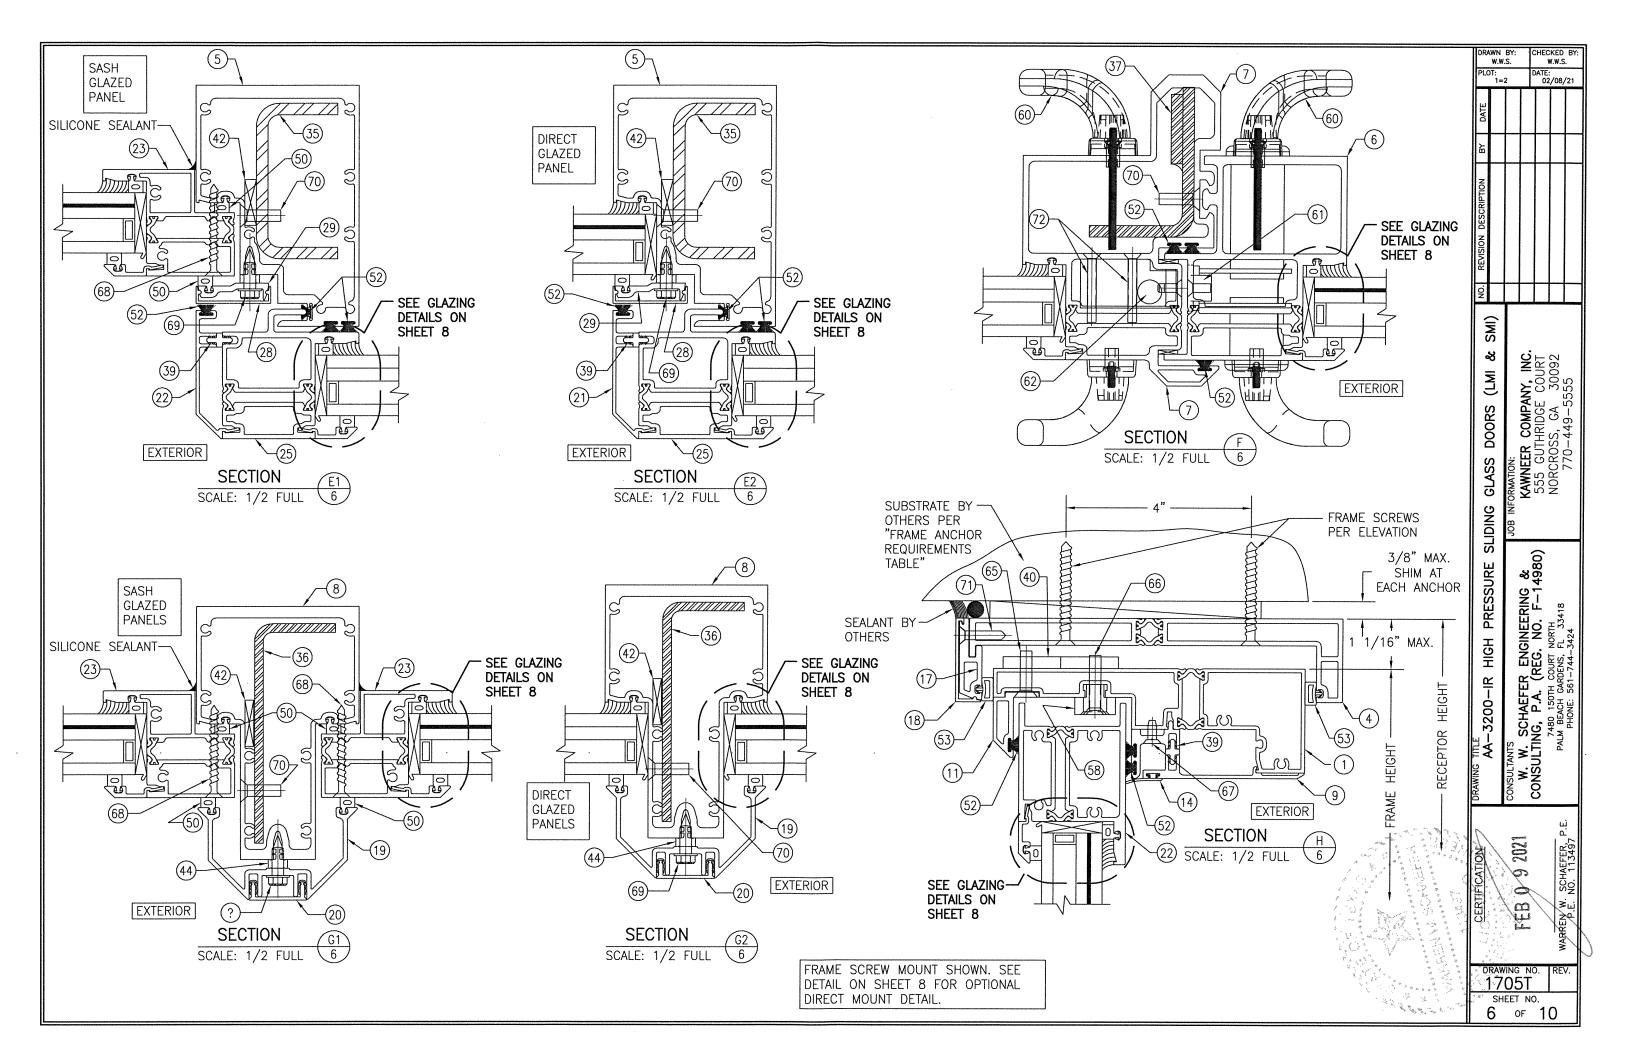

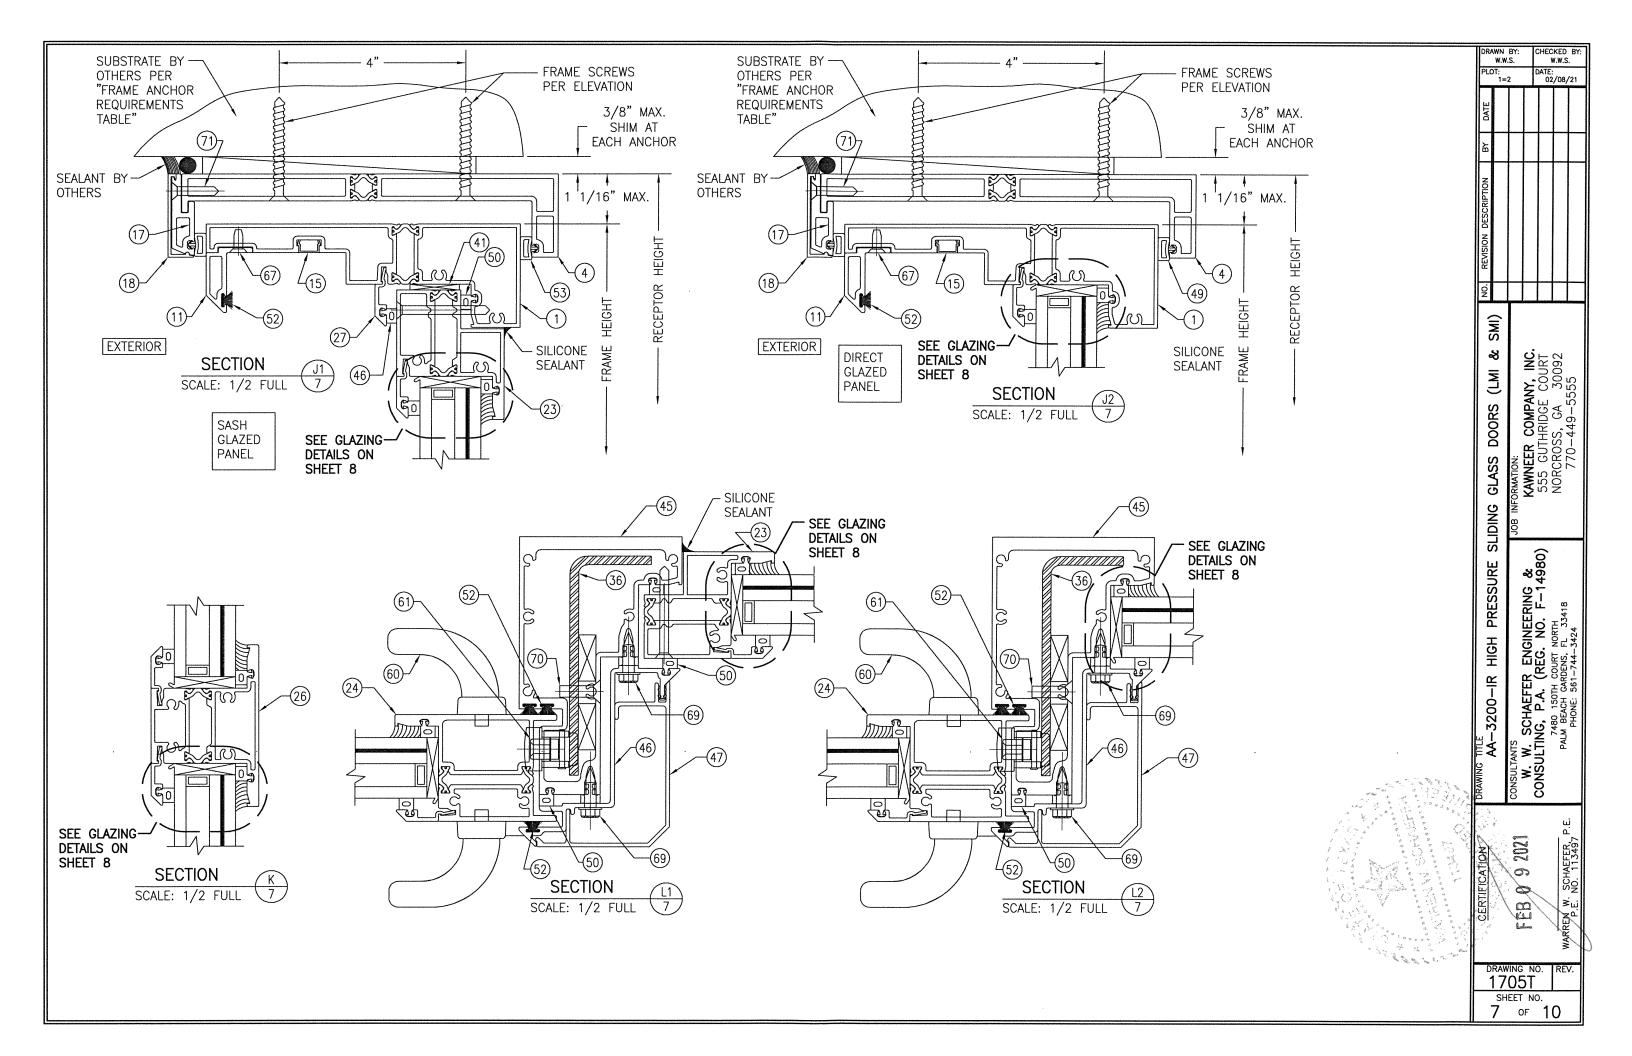

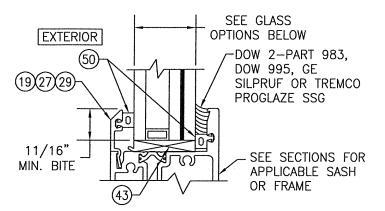


## TYPICAL GLAZING DETAIL (L.M.I. WET GLAZED)

#### **GLASS OPTIONS:**

OPTION 1: 1 5/16" I.G. WITH 1/4" TEMPERED OUTBOARD, 1/2" AIR SPACE & LAMINATED 1/4" HS/0.077" EASTMAN CHEM. CO. SAFLEX STORM/1/4" HS INBOARD OPTION 2: 1 5/16" I.G. WITH 1/4" TEMPERED OUTBOARD, 1/2" AIR SPACE & LAMINATED 1/4" HS/0.09" KURARAY SG/1/4" HS INBOARD


L.M.I. = LARGE MISSILE IMPACT S.M.I. = SMALL MISSILE IMPACT

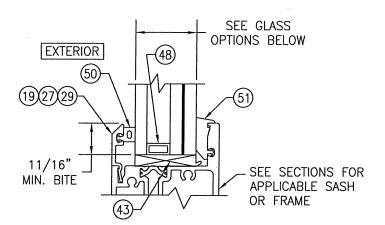

## TYPICAL GLAZING DETAIL (S.M.I. DRY GLAZED)


#### **GLASS OPTIONS:**

OPTION 3: 1 5/16" I.G. WITH 1/4" TEMP OUTBOARD, 1/2" AIR SPACE & LAMINATED 1/4" HS/0.06" EASTMAN CHEM. CO. SAFLEX/1/4" HS INBOARD OPTION 4: 1 5/16" I.G. WITH 1/4" TEMP OUTBOARD, 1/2" AIR SPACE & LAMINATED 1/4" HS/0.06" KURARAY BUTACITE PVB/1/4" HS INBOARD

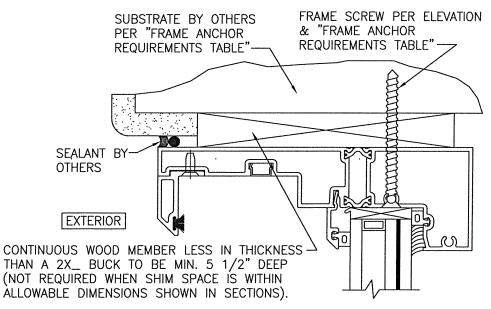

## OPTIONAL DIRECT MOUNT DETAIL TO SUBSTRATE WITH SPACER (NO HEAD RECEPTOR)

(HEAD SECTION SHOWN; SILL & SIDES ARE INSTALLED THE SAME)
(FOR DETAIL NOT SHOWN, SEE OTHER SECTIONS)

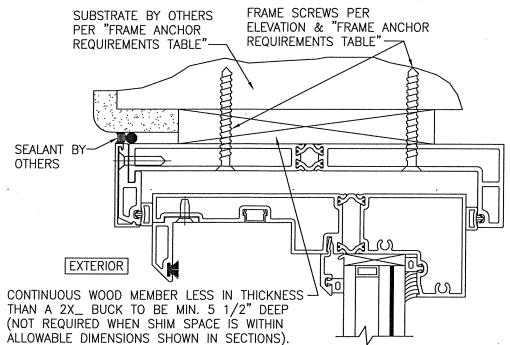

# OPTIONAL DIRECT MOUNT DETAIL TO SUBSTRATE WITH SPACER (WITH HEAD RECEPTOR)

(HEAD SECTION SHOWN; SILL & SIDES ARE INSTALLED THE SAME) (FOR DETAIL NOT SHOWN, SEE OTHER SECTIONS)

	NO. REVISION D						
	H	DRAWING TITLE AA-3200-IR HIGH PRESSURE SLIDING GLASS DOORS (LMI & SMI)	JOB INF			NORCROSS, GA 30092	770-449-5555
	DRAWING TITLE AA—3200—IR HIGH DRESSLIDE S		CONSULTANTS	W. W. SCHAEFER ENGINEERING &	CONSULTING, P.A. (REG. NO. F-14980)	7480 150TH COURT NORTH PALM BEACH GARDENS, FL 33418	TOTAL TOTAL LINCOLD
1 1 1 1 1 1 1 1 1 1 1 1 1 1 1 1 1 1 1	ICATION		9703	170%		ט כווערנינט	יייייייייייייייייייייייייייייייייייייי

1705T

SHEET NO. 8 OF 10

CHECKED BY: W.W.S. DATE: 02/08/21

