


- THIS PRODUCT HAS BEEN TESTED, ANALYZED & APPROVED FOR DESIGN PRESSURES NOT TO EXCEED THOSE SHOWN IN THE "ALLOWABLE DESIGN PRESSURE TABLE(S).
- 2. OPÉNINGS, BUCKING & BUCKING FASTENERS MUST BE PROPERLY DESIGNED & INSTALLED TO TRANSFER WIND LOADS TO THE STRUCTURE.
- 3. ALL HARDWARE & FASTENERS SHALL BE IN ACCORDANCE WITH THESE DRAWINGS & SHALL NOT VARY UNLESS SPECIFICALLY MENTIONED ON THE DRAWINGS. SPECIFIED ANCHOR EMBED TO BASE MATERIAL SHALL BE BEYOND WALL FINISH OR STUCCO. 4. THE DETAILS & SPECIFICATIONS SHOWN HEREIN REPRESENT THE PRODUCTS
- TESTED & PROPOSED FOR IMPACT, CYCLIC & UNIFORM STATIC AIR PRESSURE TESTING IN CONFORMANCE WITH 2018 IBC REFERENCED STANDARDS ASTM E330, E1886 & E1996 FOR LARGE MISSILE IMPACT PRODUCTS. ALL TESTING OF THIS PRODUCT TO STANDARDS LESS CURRENT THAN THOSE SPECIFIED IN THE 2018 IBC HAS BEEN DETERMINED EQUIVALENT TO THE MORE CURRENT VERSIONS OF THOSE STANDARDS REFERENCED IN THE 2018 IBC
- 5. THIS PRODUCT HAS BEEN DESIGNED IN ACCORDANCE WITH AND MEETS THE REQUIREMENTS OF THE 2018 INTERNATIONAL BUILDING CODE (IBC).
- 6. IMPACT SHUTTERS ARE NOT REQUIRED WITH THIS PRODUCT.
 7. ALL ANCHORS SECURING PRODUCT FRAMES TO PRESSURE TREATED BUCKS OR WOOD FRAMING SHALL BE CAPABLE OF RESISTING CORROSION CAUSED BY THE
- PRESSURE TREATING CHEMICALS IN THE WOOD. 8. DETERMINE THE POSITIVE & NEGATIVE DESIGN LOADS TO USE WHEN REFERENCING THESE DOCUMENTS IN ACCORDANCE WITH THE GOVERNING CODE AND GOVERNING WIND VELOCITY. FOR WIND LOAD CALCULATIONS IN ACCORDANCE WITH THE INTERNATIONAL BUILDING CODE, A DIRECTIONALITY FACTOR OF KD = 0.85 MAY BE APPLIED PER THE ASCE-7 STANDARD
- 9. MATERIALS, INCLUDING BUT NOT LIMITED TO STEEL SCREWS, THAT COME INTO CONTACT WITH OTHER DISSIMILAR MATERIALS SHALL BE SEPARATED OR COATED AS REQUIRED TO AVOID CORROSION OF EITHER MATERIAL
- 10. TO THE BEST OF OUR KNOWLEDGE, THE PRODUCT SHOWN HEREIN ARE QUALITY ASSURED BY AN APPROVED CERTIFICATION/QA ENTITY & SHALL BE LABELED IN ACCORDANCE WITH APPLICABLE STANDARDS. THESE DRAWINGS SHOW ALL APPLICABLE ELEVATION, COMBINATION, INSTALLATION & COMPARATIVE ANALYSIS CONDITIONS AS DETERMINED THROUGH TESTING & ENGINEERING RATIONAL ANALYSIS. PRODUCT ASSEMBLY SHALL BE IN ACCORDANCE WITH THESE DRAWINGS, THE MANUFACTURER'S QUALITY ASSURANCE SPECIFICATIONS & TESTING REPORTS.
- 11. CERTIFICATION OF THIS PRODUCT SHALL BE CONSIDERED VOID IF THEY ARE INSTALLED WITHOUT A BUILDING PERMIT FROM THE APPLICABLE LOCAL BUILDING DEPARTMENT OR IF THEY ARE INSTALLED BY ANYONE OTHER THAN A LICENSED CONTRACTOR EXPERIENCED WITH INSTALLATIONS OF THIS TYPE OF PRODUCT.

EVALUATION OF THIS PRODUCT IS BASED ON APPLICABLE STANDARDS AND/OR INFORMATION & RESULTS FROM APPLICABLE TEST REPORTS. THE BUILDING CODE VERSION CONSIDERED WITH THIS EVALUATION WAS THAT IN FORCE AT THE TIME OF THE EVALUATION. IN THE EVENT OF CODE VERSION CHANGES/UPDATES OR IN THE EVENT THAT NEW OR ADDITIONAL TESTING IS COMPLETED ON THIS PRODUCT, PRIOR TO STATING CODE COMPLIANCE, THE MANUFACTURER SHALL CONFIRM WITH THE EVALUATION ENGINEER OF RECORD THAT EVERYTHING SPECIFIED HERE—IN IS CURRENT WITH ALL CURRENT TESTING, CODES AND APPLICABLE STANDARDS.

NOTE: THESE DOOR UNITS ARE NOT APPROVED FOR USE WHERE WATER INFILTRATION RESISTANCE IS REQUIRED BY THE DOOR UNLESS THE UNITS ARE INSTALLED IN NON-HABITABLE AREAS WHERE THE UNIT & THE AREA ARE DESIGNED TO ACCEPT WATER INFILTRATION OR THE UNITS ARE INSTALLED AT LOCATIONS PROTECTED BY A CANOPY OR OVERHANG WHERE-BY THE OVERHANG(OH) RATIO IS EQUAL TO OR MORE THAN 1.0 PER FBC.

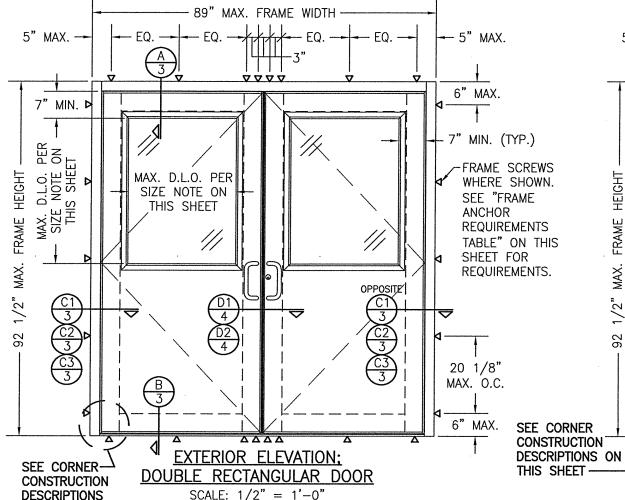

TO AVOID CONFUSION, LOCK & 1 NOT IN PRE SHE SHE HINC

ON THIS SHEET

FRAME ANCHOR REQUIREMENTS TABLE				
FRAME SCREWS				
OPENING TYPE (SUBSTRATE)	FRAME TO OPENING FASTENER TYPE	MINIMUM EMBED	MINIMUM EDGE DIST.	
(2) MIN. 2X6 WOOD FRAME OR BUCK (MIN. GR. 3 & G=0.55)	NO. 12 SMS OR WOOD SCREW	1 1/4"	7/8"	
MIN. 18 GA. 33 KSI METAL STUD	NO. 12 GR. 5 SELF TAP/DRILL SCREW	FULL	1/2"	
MIN. 1/8" THK A36 STEEL	NO. 12 GR. 5 SELF TAP/DRILL SCREW	FULL	1/2"	
MIN. 0.1" THK 6063-T5 ALUM.	NO. 12 GR. 5 SELF TAP/DRILL SCREW	FULL	1/2"	
MIN. C-90 CONCRETE FILLED CMU OR SOLID 2500 PSI CONCRETE	(1) 1/4" CONCRETE SCREW	1 3/4"	2"	

FRAME ANCHOR REQUIREMENTS TARIE

- (1) CONCRETE SCREWS SHALL BE ELCO ULTRACONS (C.S.), ELCO CRETE-FLEX (S.S.), ITW RAMSET/RED HEAD TAPCONS (C.S. OR S.S.) OR HILTI KWIK-CON II (C.S OR S.S.)
- (2) 2X6 BUCKS SHALL BE OF A MINIMUM DEPTH REQUIRED TO MEET ANCHOR EDGE DISTANCE REQUIREMENTS BUT NO LESS THAN 4 1/2".

HINGE CONDITIONS ARE T CALLED OUT/SPECIFIED THE ELEVATIONS. SEE			
ESSURE TABLE ON THIS EET & PARTS LIST ON EET 7 FOR ALL LOCK &	ALLOWABLE DESIGN PRESSURE (INDIVIDUAL & TRANSOM UNITS)		
IGE OPTIONS.	LOCK ALLOWABLE DESIGN WIND ZONE		

(INDI\	VIDUAL & TRANSOM	UNITS)	
LOCK CONDITION	ALLOWABLE DESIGN PRESSURE (DP)		
	I		
1	+/-70 PSF	4	
2	+/-70 PSF	4	
3	+/-50 PSF	3	
SINGLE DOORS			
1	+/-70 PSF	4	
2	+/-70 PSF	4	
3	+/-70 PSF	3	
4	(1) +/-75 PSF	4	
1) ONLY A	CONTINUOUS GEAR	HINGE IS	

APPLICABLE FOR USE WHEN DP EXCEEDS +/-70 PSF.

SINGLE RECTANGULAR DOOR SCALE: 1/2" = 1'-0"DOOR GLASS D.L.O. SIZE NOTE: DIMENSIONS OF THE DOOR PANEL D.L.O. SHALL BE SUCH THAT THE OVERALL D.L.O. AREA DOES NOT EXCEED 7.36 SQ. FT. (1060 SQ. IN.)

- 47" MAX. FRAME WIDTH ·

MAX. D.L.O. PER

SIZE NOTE ON

THIS SHEET

EXTERIOR ELEVATION:

OPPOSITE

3/

5" MAX. --

MIN. D

MAX. D.L.O. PER SIZE NOTE ON . THIS SHEET

4

HEIGHT

FRAME

MAX.

1/2"

LOCK CONDITION 1:

3-POINT LOCK ITEM #39 AT SINGLE DOOR AND ACTIVE PANEL OF DOUBLE DOOR; TOP & BOTTOM FLUSH BOLTS ITEM #40 & 41 AT INACTIVE PANEL OF DOUBLE DOOR. LOCK CONDITION 2:

KAWNEER 1686 EXIT DEVICE ITEM #42 AT EACH PANEL (SINGLE & DOUBLE DOORS) LOCK CONDITION 3:

CORBIN RUSWIN EXIT DEVICE ITEM #43 AT EACH PANEL (SINGLE & DOUBLE DOORS) WITH REMOVABLE MULLION AT DOUBLE DOORS. LOCK CONDITION 4:

SCHLAGE MORTISE LOCK ITEM #44 (SINGLE DOORS ONLY)

TITLE FLUSHLINE IESE DRAWINGS ARE APPLICABLE ONLY TO THE PRODUC SPECIFIED. THEY MAY NOT BE USED FOR THE ASSEMBLY AND/OR INSTALLATION OF ANY OTHER PRODUCT NOR MAY 1913T THEY BE USED FOR RATIONAL AND/OR LOCAL APPROVAL SHEET NO.

OF ANY PRODUCT NOT PRODUCED BY THE MANUFACTURES STATED ON THESE DRAWINGS.

CHECKED BY

03/04/21

KAWNEER COMPANY, INC. 555 GUTHRIDGE COURT NORCROSS, GA 30092 770-449-5555

CONSULTANTS

W. W. SCHAEFER ENGINEERING & CONSULTING, P.A. (REG. NO. F-14980)
7480 150TH COURT NORTH
PALM BEACH GARDENS, FL. 33418
PHONE: 561-744-3424

FRAMES

IR501

WITH

DOORS

IMPACT

4 2021

MAR O

OF

1=24

- 5" MAX.

6" MAX.

MIN. (TYP.)

SEE "FRAME

SHEET FOR

ANCHOR

20 1/8"

MAX. O.C.

6" MAX


FRAME SCREWS

WHERE SHOWN.

REQUIREMENTS

REQUIREMENTS.

TABLE" ON THIS

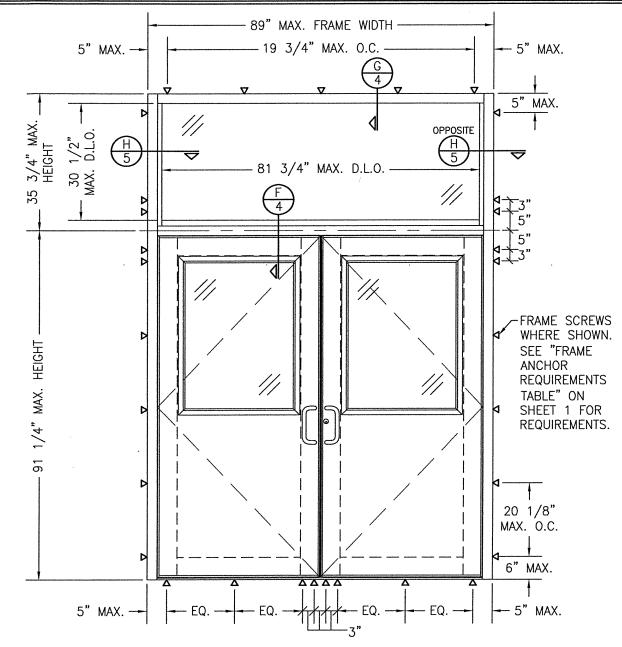

EXTERIOR ELEVATION; DOUBLE DOOR WITH TRANSOM SCALE: 1/2" = 1'-0"

(FOR ALL DETAIL NOT SHOWN, SEE DOUBLE DOOR ELEVATION ON SHEET 1)


CORNER CONSTRUCTION:

TRANSOM FRAME HEAD CORNER: VERTICAL FRAME MEMBERS RUN THROUGH WHILE THE HORIZONTAL FRAME MEMBER IS SQUARE CUT, BUTTED AND MECHANICALLY FASTENED WITH 3 NO. 12 X 1" PHTF THROUGH THE VERTICAL MEMBERS INTO THE HORIZONTAL MEMBER SCREW SPLINES. CORNERS ARE SEALED WITH DOW 795 SILICONE SEALANT.

DOOR HEAD FRAME ENDS/CORNER: VERTICAL FRAME MEMBERS RUN THROUGH WHILE THE HORIZONTAL DOOR HEAD MEMBER IS SQUARE CUT, BUTTED AND MECHANICALLY FASTENED TO THE VERTICAL MEMBERS VIA 3 NO. 12 X 1" PHTF THROUGH THE VERTICAL MEMBERS INTO THE HORIZONTAL MEMBER SCREW SPLINES AND A SHEAR BLOCK (ITEM #17). THE SHEAR BLOCK IS MECHANICALLY FASTENED TO THE VERTICAL FRAME MEMBER WITH 4 NO. 10 X 1 19/32" PHTF SCREWS. CORNERS ARE SEALED WITH DOW 795 SILICONE SEALANT.

FRAME SILL CORNER: VERTICAL FRAME MEMBERS RUN THROUGH WHILE THE SILL MEMBER IS SQUARE CUT, BUTTED TO THE VERTICAL FRAME MEMBERS & SECURED TO EACH FRAME MEMBER WITH AN ANGLE CLIP ITEM #24. THE ANGLE CLIP IS SCREWED TO THE SILL & FRAME MEMBERS WITH NO. 12 -24 X 3/8" FHMS SCREWS (2 AT SILL; 3 AT FRAME). CORNERS ARE SEALED WITH DOW 795 SILLCONE SEALANT.


DOOR PANEL CORNER: VERTICAL STILES RUN THROUGH AND ARE SECURED TO THE RAILS AT THE TOP & BOTTOM WITH A WELD CLIP ITEM #25. EACH WELD CLIP IS FASTENED TO THE STILE & RAIL WITH TWO(2) 1/4-20 X 3/4" PHMS & 3/16" THICK STEEL NUT PLATES. THE INTERSECTION OF EACH CORNER JOINT IS WELDED WITH A 1/2" DIA. PLUG WELD AND A 1 1/8" LONG FILLET WELD AT BOTH WEBS OF THE RAIL.

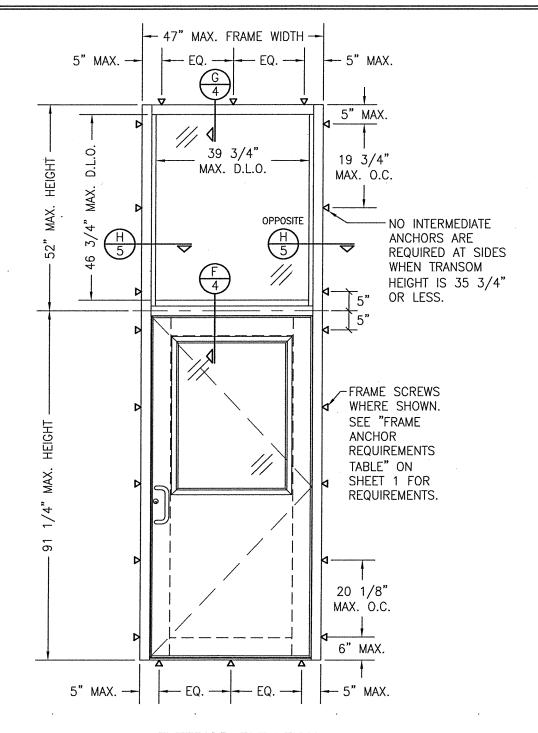

EXTERIOR ELEVATION: SINGLE DOOR WITH TRANSOM

SCALE: 1/2" = 1'-0"


(FOR ALL DETAIL NOT SHOWN, SEE SINGLE DOOR ELEVATION ON SHEET 1)

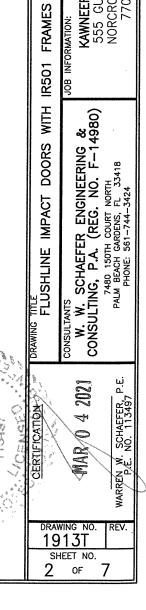



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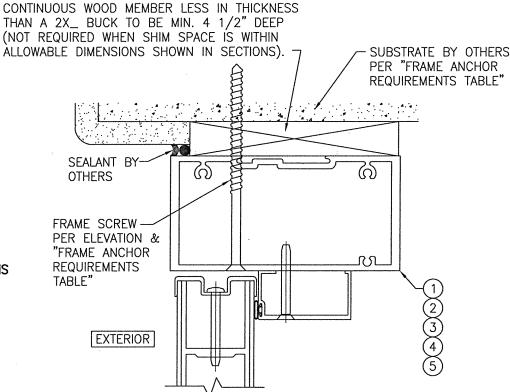
> ATE: 03/04/21

.OT: 1=24



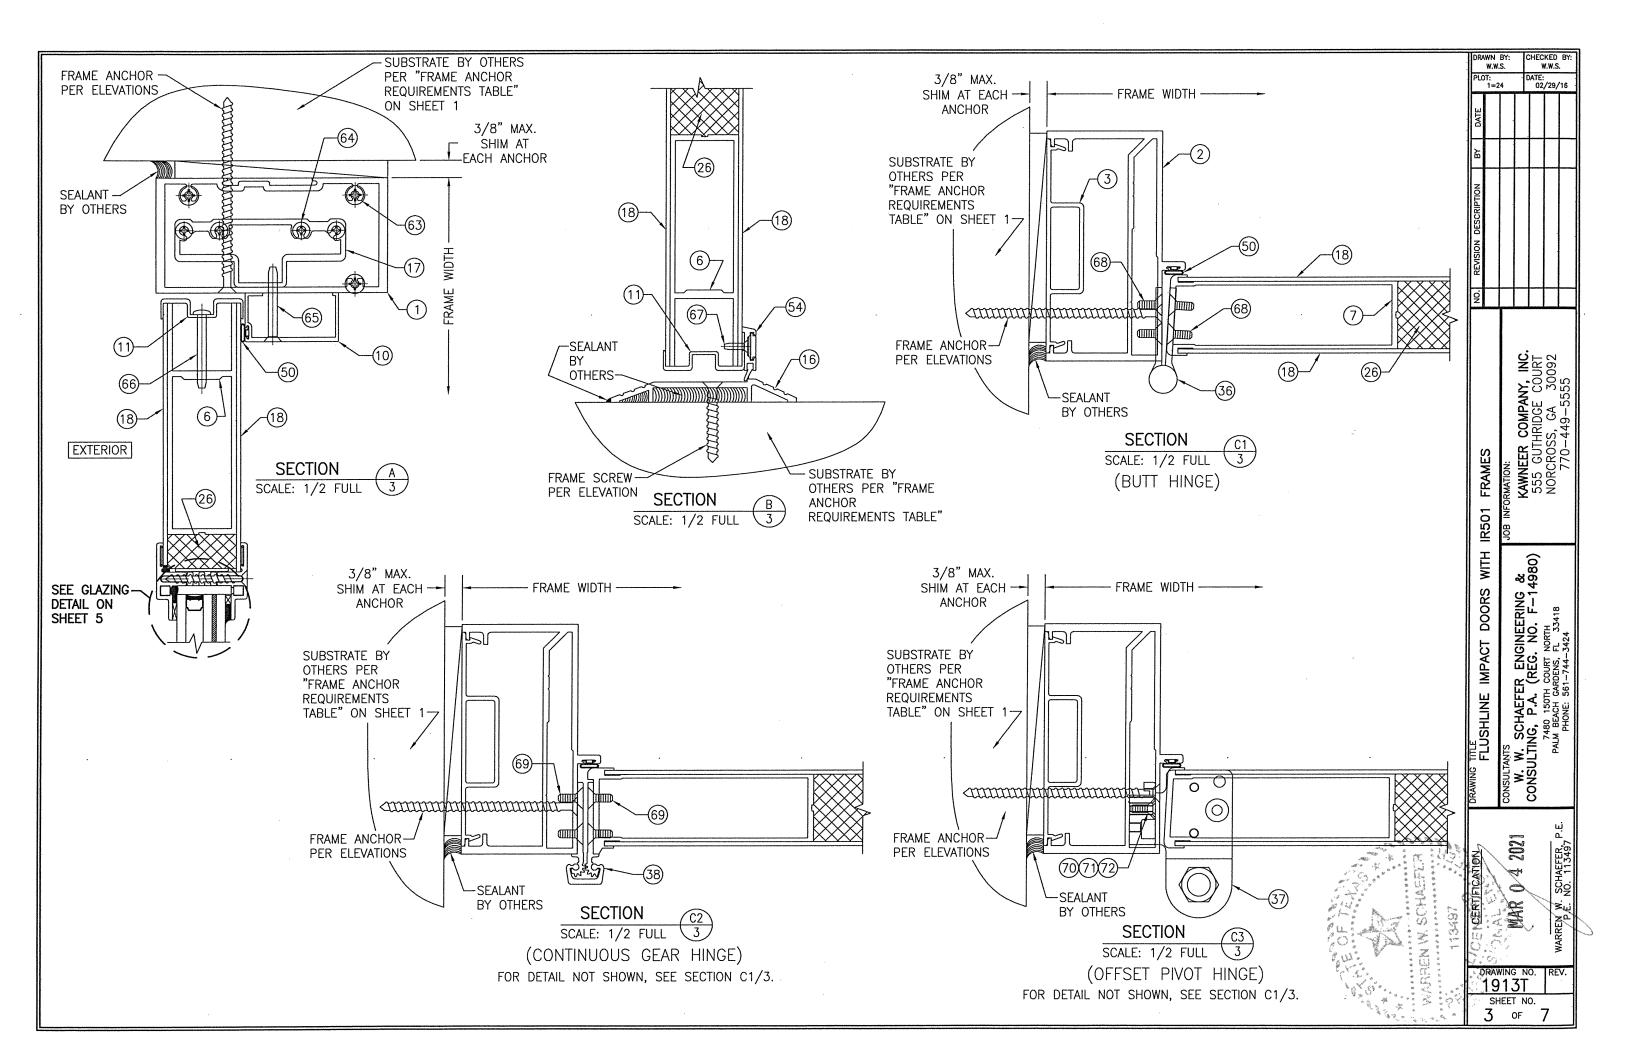


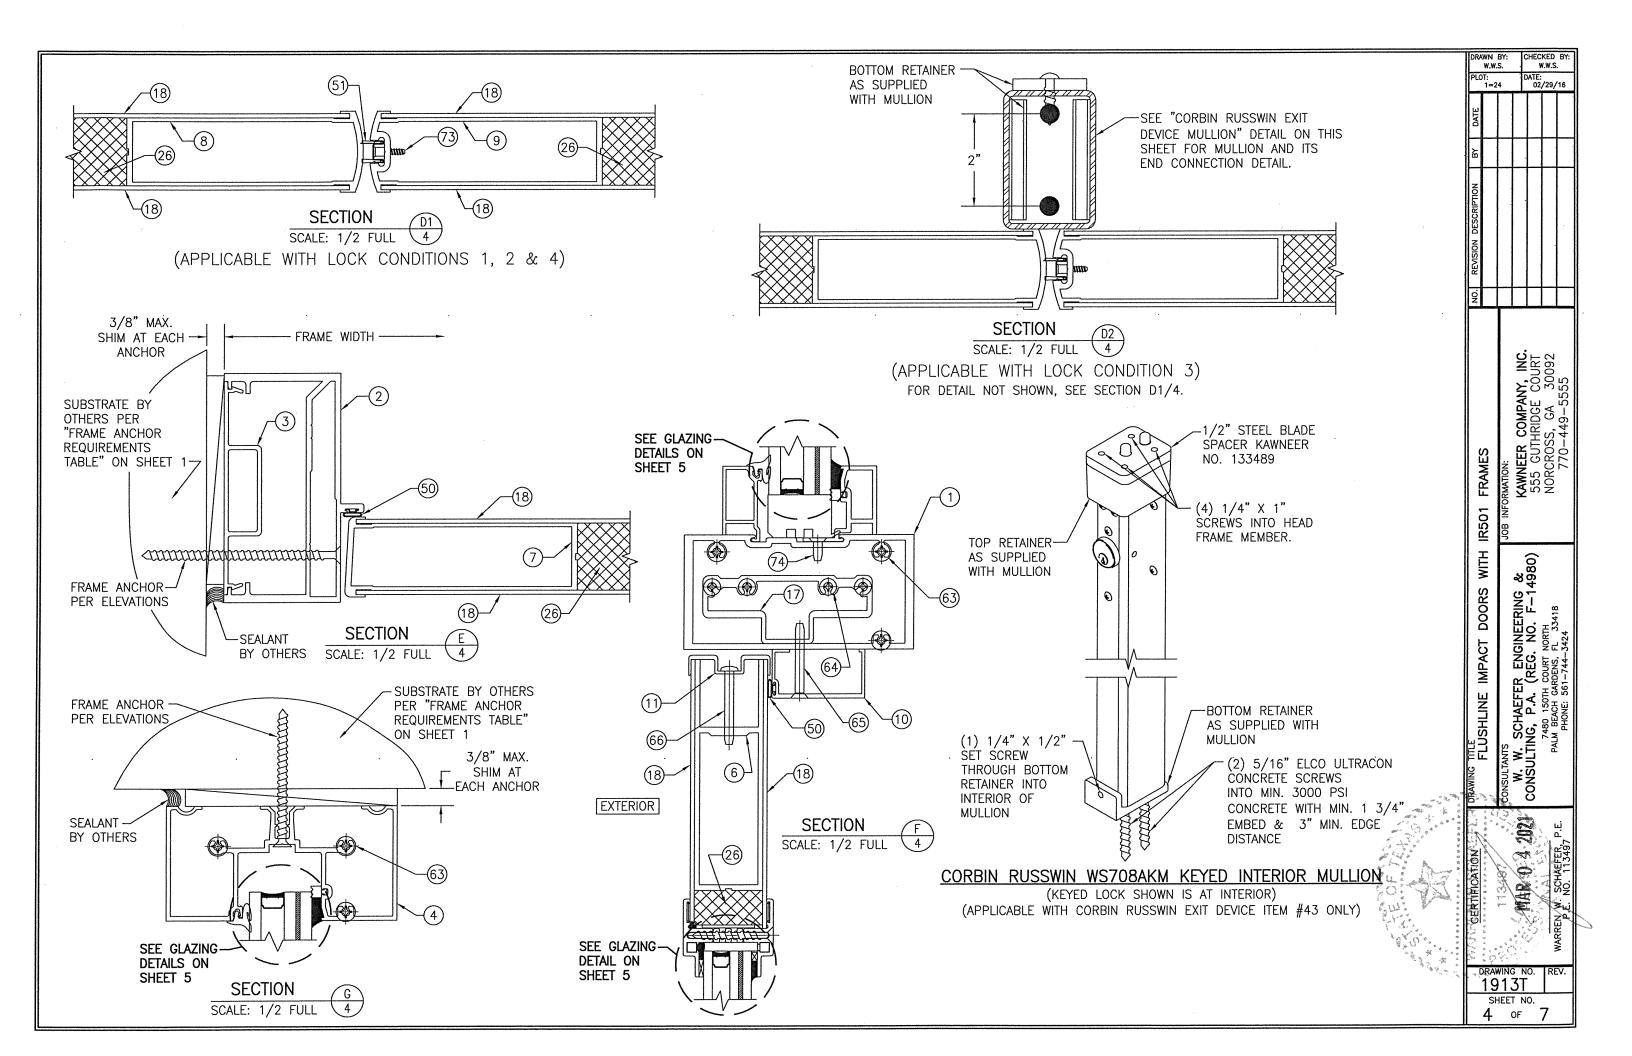

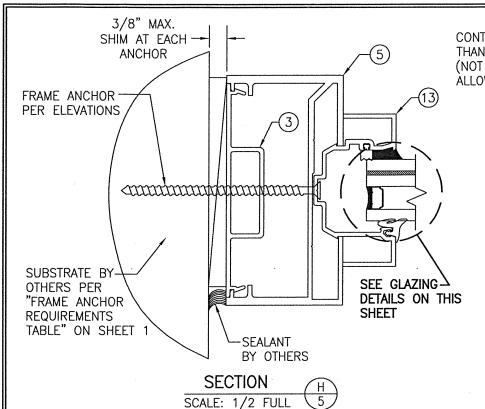

OPTIONAL DIRECT MOUNT DETAIL TO SUBSTRATE WITH SPACER


(HEAD SECTION SHOWN; SIDES ARE INSTALLED THE SAME) (FOR DETAIL NOT SHOWN, SEE OTHER SECTIONS)

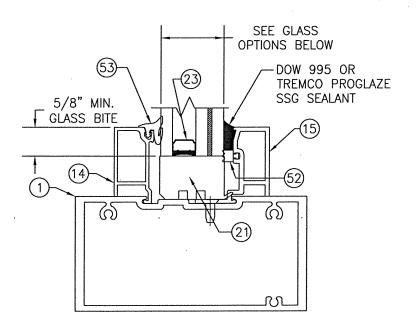

TYPICAL TRANSOM SILL GLAZING DETAIL **GLASS OPTIONS:**

OPTION 1: 1 5/16" THICK I.G. GLASS (1/4" TEMP EXTERIOR; 1/2" SPACER; 1/4" HS/0.09 EASTMAN CHEM. CO. SAFLEX/1/4" HS INTERIOR


OPTION 2: 1 5/16" THICK I.G. GLASS (1/4" TEMP EXTERIOR: 1/2" SPACER: 1/4" HS/0.09 KURARAY BUTACITE PVB/1/4" HS INTERIOR

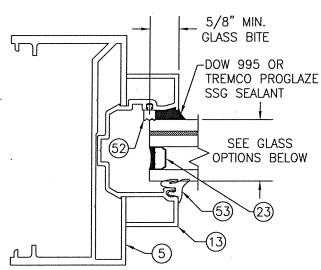

TYPICAL TRANSOM JAMB GLAZING DETAIL **GLASS OPTIONS:**

OPTION 1: 1 5/16" THICK I.G. GLASS (1/4" TEMP EXTERIOR; 1/2" SPACER; 1/4" HS/0.09 EASTMAN CHEM. CO. SAFLEX/1/4" HS INTERIOR

OPTION 2: 1 5/16" THICK I.G. GLASS (1/4" TEMP EXTERIOR; 1/2" SPACER; 1/4" HS/0.09 KURARAY BUTACITE PVB/1/4" HS INTERIOR

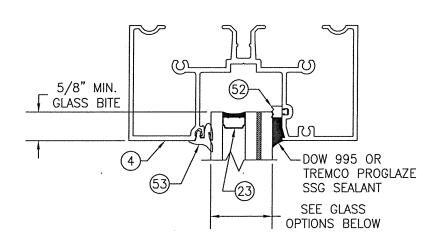

DOW 995 OR

SSG SEALANT -

TREMCO PROGLAZE

9/16" MIN.

GLASS OPTIONS:

CO. SAFLEX/3/16" HS INTERIOR

PVB/3/16" HS INTERIOR

TYPICAL DOOR PANEL GLAZING DETAIL

OPTION 1: 1 1/32" THICK I.G. GLASS (3/16" TEMP

OPTION 2: 1 1/32" THICK I.G. GLASS (3/16" TEMP

EXTERIOR; 3/8" SPACER; 3/16" HS/0.09 EASTMAN CHEM.

EXTERIOR; 3/8" SPACER; 3/16" HS/0.09 KURARAY BUTACITE

GLASS BITE


CONT. SILICONE-

SEALANT

EXTERIOR

TYPICAL TRANSOM HEAD GLAZING DETAIL **GLASS OPTIONS:**

OPTION 1: 1 5/16" THICK I.G. GLASS (1/4" TEMP EXTERIOR; 1/2" SPACER; 1/4" HS/0.09 EASTMAN CHEM. CO. SAFLEX/1/4" HS INTERIOR OPTION 2: 1 5/16" THICK I.G. GLASS (1/4" TEMP EXTERIOR; 1/2" SPACER; 1/4" HS/0.09 KURARAY BUTACITE PVB/1/4" HS INTERIOR

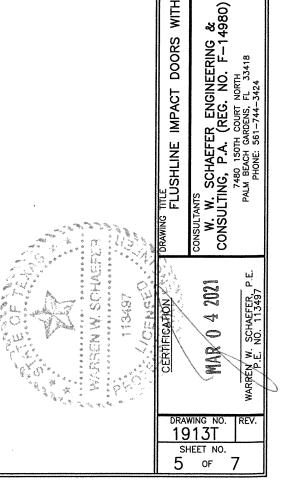

CHECKED BY: W.W.S.

DATE: 02/29/16

KAWNEER COMPANY, INC. 555 GUTHRIDGE COURT NORCROSS, GA 30092 770-449-5555

FRAMES

IR501

WITH

LOT: 1=24

SEE GLASS OPTIONS BELOW

/-3/16" X 1 1/4" X 4 1/8'

LONG SETTING BLOCKS AS

REQ'D AT BASE OF GLASS

DOW 995 OR


SSG SEALANT

TREMCO PROGLAZE

NO. 10 X 1 3/4"


4" OF CORNERS AND MAX. 11 5/8" O.C.


57 FH AB SCREW WITHIN

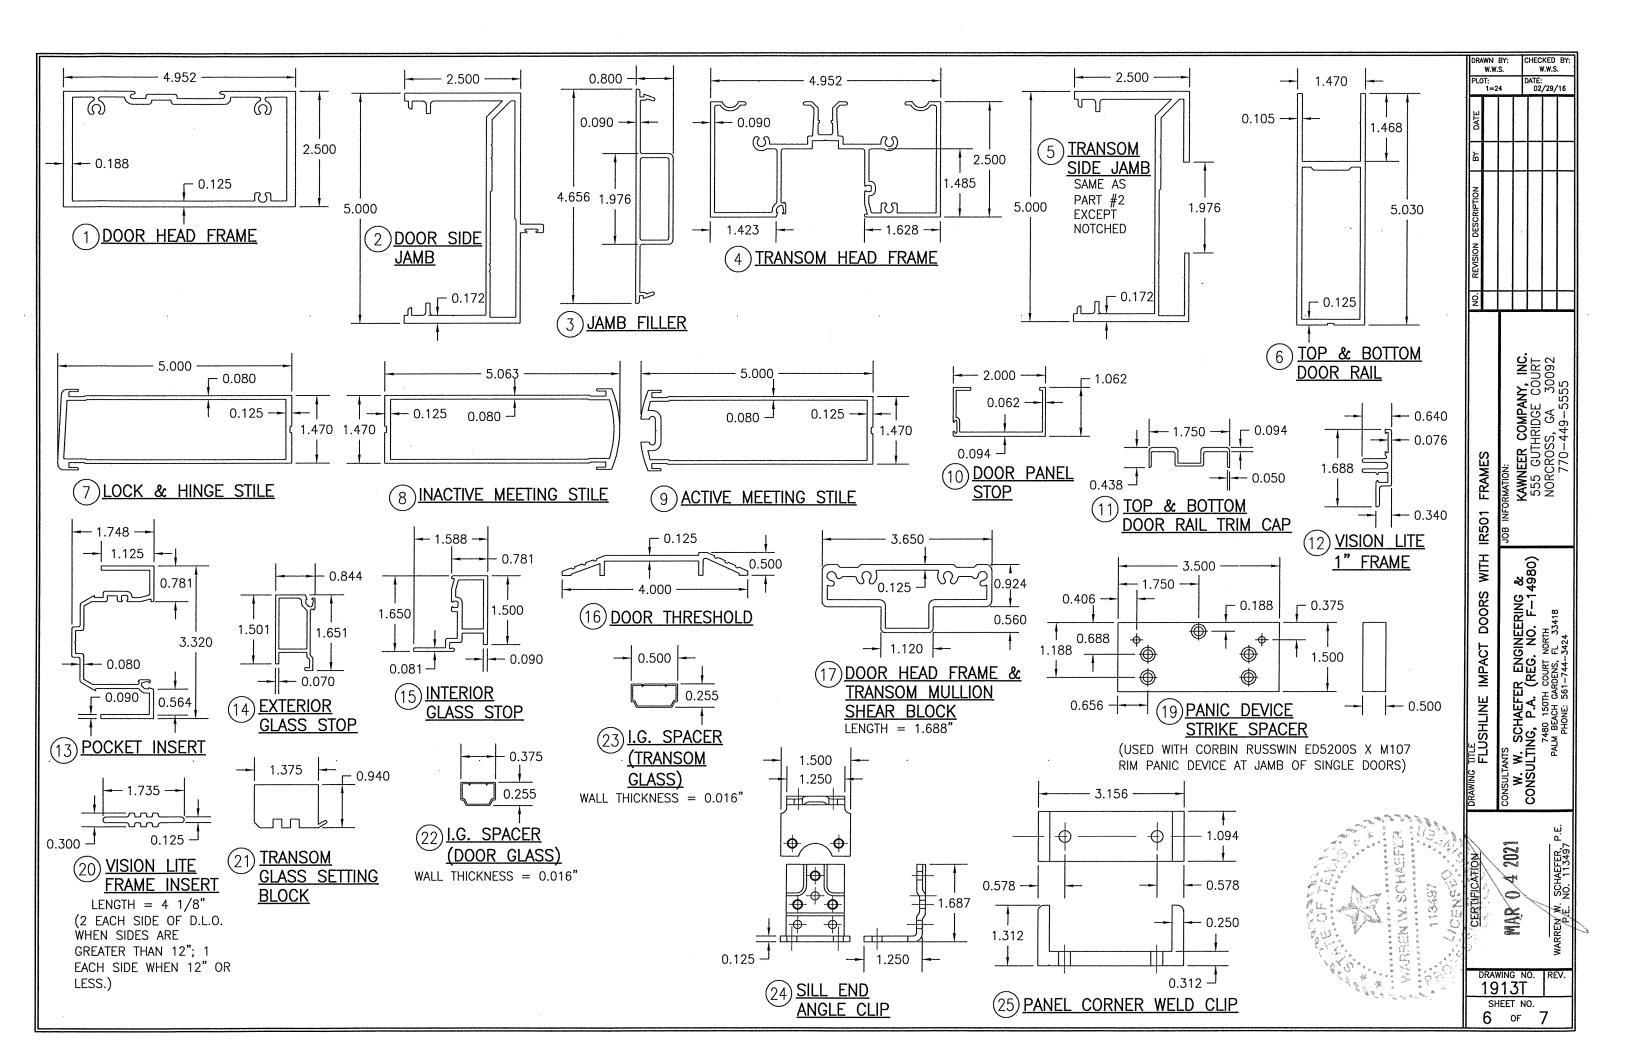

ЕМ #	ITEM DESCRIPTION	MANUFACTURER/NOTES
	PARTS	
	DOOR HEAD FRAME	6063-T6 ALUMINUM
	DOOR SIDE JAMB	6063-T6 ALUMINUM
	JAMB FILLER	6063-T6 ALUMINUM
	TRANSOM HEAD FRAME	6063-T6 ALUMINUM
	TRANSOM SIDE JAMB	6063-T6 ALUMINUM
6	TOP & BOTTOM DOOR RAIL	6063-T6 ALUMINUM
	LOCK & HINGE STILE	6063-T6 ALUMINUM
8	INACTIVE MEETING STILE	6063-T6 ALUMINUM
9	ACTIVE MEETING STILE	6063-T6 ALUMINUM
10	DOOR PANEL STOP	6063-T6 ALUMINUM
11	TOP & BOTTOM DOOR RAIL TRIM CAP	6063-T6 ALUMINUM
12	VISION LITE 1" FRAME (GLASS STOP)	6063-T6 ALUMINUM
	POCKET INSERT	6063-T6 ALUMINUM
	EXTERIOR GLASS STOP	6063-T6 ALUMINUM
	INTERIOR GLASS STOP	6063-T6 ALUMINUM
	DOOR THRESHOLD	6063-T6 ALUMINUM
	DOOR HEAD/TRANSOM MULLION SHEAR BLOCK	6063-T6 ALUMINUM
	0.09" THICK DOOR PANEL SHEET	FIBER REINFORCED PLASTIC OR 5005 ALUMINUM
	PANIC DEVICE STRIKE SPACER	ALUMINUM; USED W/ITEM #43 & SINGLE DOOR ONLY
	VISION LITE FRAME INSERT	ABS BLACK
I	TRANSOM GLASS SETTING BLOCK	EPDM
	DOOR GLASS IG SPACER	A93105 ALUMINUM
		·
	TRANSOM GLASS IG SPACER	A93105 ALUMINUM
	SILL END ANGLE CLIP	HR STEEL
	PANEL CORNER WELD CLIP	6063-T6 ALUMINUM
	FOAM FILL	5.0 LB/CF PVC FOAM CORE
27	VISION-LITE CORNER KEY	DIE CAST ZINK
	HARDWARE	T
	4.5" X 4" BALL BEARING BUTT HINGE	HAGAR A797 304 SS NRP
37	OFFSET PIVOT HINGE	TOP PIVOT: KAWNEER NO. 050300/035520
I		INTERMEDIATE PIVOT: KAWNEER NO. 037233/037234
		BOTTOM PIVOT: KAWNEER NO. 037837/035524/035523
38	CONTINUOUS GEAR HINGE	KAWNEER NO. 050821
39	3-POINT MULTI-POINT ACTIVE DOOR LOCK	KAWNEER NO. T237601
40	INACTIVE DOOR TOP FLUSH BOLT	KAWNEER NO. 050079
41	INACTIVE DOOR BOTTOM FLUSH BOLT	KAWNEER NO. 050079
42	CONCEALED ROD EXIT/PANIC DEVICE	KAWNEER 1686
43	RIM PANIC DEVICE WITH KEYED REMOVABLE MULLION	CORBIN RUSSWIN ED5200S(A)
	MORTISE LOCK	SCHLAGE L9453L PACKAGE
	SEALS & SEALANTS	
50	WEATHERING BULB	ALCRYN/RIGID PVC (DUROMETER = 60)
	ADJUSTABLE ASTRIGAL SEAL	SS/NYLON/POLYURETHANE
	SPACER	TPV; POLYPROPYLENE
	GLAZING GASKET	EPDM SHORE A (DUROMETER = $65 + /-5$)
	DOOR SWEEP BASE, FILLER STRIP & WEATHER STRIP	
	1/8" X 3/16" SPACER	POLYURETHANE FOAM
	3/16" X 3/8" GLAZING TAPE	CLOSED CELL PVC
	1/8" X 3/8" GLAZING TAPE	CLOSED CELL PVC
J/ .		OLOGED OFFE FAC
	NO. 12 X 1" PHTF SCREWS	7 DED EDAME CODNED
C7 T	NO LA Y E PHIE SUPEWS	3 PER FRAME CORNER
64	NO. 10 X 1 19/32" PHTF SCREWS NO. 10 X 1 5/8" FHTF TYPE "B" SCREWS	4 PER SHEAR BLOCK 1" FROM ENDS & MAX. 16" O.C.

ITEM #	ITEM DESCRIPTION	MANUFACTURER/NOTES
FASTENERS CONT'D		
67	NO. 8 X 1/2" FHTF TYPE "B" SCREWS	1/4" FROM ENDS & MAX. 9 1/2" O.C.
68	NO. 12-24 X 9/16" SS FH SCREW	4 PER BUTT HINGE LEAF
69	NO. 12-24 X 11/16" SS FH SCREWS	2 9/16" FROM ENDS & MAX. 5 1/8" O.C.
70	5/16"-18 X 5/8" SS SCREW	2 PER TOP PIVOT HINGE
71	NO. 12-24 X 9/16" SS SCREW	2 PER INTERMEDIATE PIVOT HINGE
	1/4-20 X 3/8" SS SCREW	3 PER BOTTOM PIVOT HINGE
	0.279-0.188 DIA. X 0.563" LONG ADJUSTING SCREW	POSITIONED AS REQUIRED BY KAWNEER
74	NO. 10 X 1/2" FHTF SCREW	3" FROM ENDS & MAX. 18" O.C.

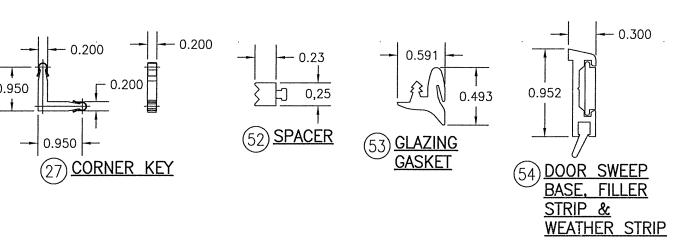

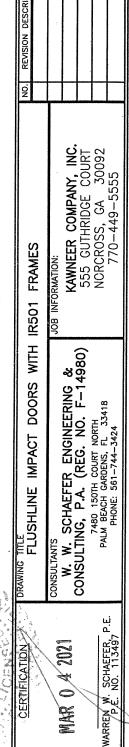

DRAWING NO. 1 1913T SHEET NO. 7 OF 7

CHECKED BY: W.W.S.

DATE: 02/29/16

DRAWN BY: W.W.S. PLOT: 1=24